DEPART 1801 VALLEY NEW LM, DALLAS, TX 75234 [1801 VALLEY NEW LM, DALLAS, TX 75234]

ON VALLEY NEW LM (SOUTH-WEST)D.3 M

TURN LETT (SOUTH) ONTO LEMA PRO.9 M

TAKE RAWP (LETT) ONTO 16453 [LB. FWY]D.3 MIR-B3.5 E / 1-3.5 E

AT EXT 720, TURN ROCH ONTO RAWPO.3 MIR-B3.5 E / 1-3.5 E

AT EXT 720, TURN ROCH ONTO RAWPO.3 MIRALES NORTH TOLLWAY SOUTH

TOLL ROOM PRECE ONTO DALLAS NORTH TOLLWAY, SOUTH

TOLL ROOM PRECE ONTO DALLAS NORTH TOLLWAY, SOUTH

TURN LETT (SOUTH) ONTO LOCAL ROAD(S)(27 YDS

TURN LETT (SOUTH) ONTO LOCAL ROAD(S)(27 YDS

TURN LETT (SOUTH) ONTO LOCAL ROAD(S)(37 YDS

TURN LETT (SOUTH) ONTO LOCAL ROAD(S)(37 YDS entenary Dr Caruth Blvd Colgan Ave Nonpassi Play LATITUDE: POWER CO. JURISDICTION: LONGITUDE: TELEPHONE CO.: SCOPE OF WORK: Marquella SI PROPERTY OWNER: ADDRESS: DITY, STATE, OWER OWNER: APPLICANT/LEASSEE: Beamore Co ZIP: PROJECT INFORMATION ZIP: ZIP: ×. Doi Note La Chevy Chase Ave DRIVING Northwest Dandera Ave UNKNOWN UNKNOWN CITY OF UNIVERSITY PARK 613' (NAD88) COLOCATION ON EXISTING WATER TOWER -96° 47' 25.00" (NAD83) 32" 51' 54.22" (NAD83) VICINITY CITY OF UNIVERSITY PARK CITY OF UNIVERSITY PARK AT&T MOBILITY 1801 VALLEY VIEW LANE FARMERS BRANCH, TX 75234 DIRECTIONS Roy C. Coffee Park Tunte Creek Blvd Greenbier Dr MAP est Delgache Ave Dallas horthwood Ro PROJECT SITE Centerary Ave DOCKREAM E hothwest Flwy က္က 15 ազդող Villanova St UNIVERSITY PARK WATER TOWER SITE 3533 E. NORTHWEST PKWY **PHOTO** 1801 VALLEY VIEW LANE FARMERS BRANCH, TX 75234 ALLAS, TX 75225 (DALLAS COUNTY) SITE ADDRESS SITE NAME ENGINEER:
NAME:
NAME:
ADDRESS:
CITY, STATE,
CONTACT:
PHONE: at&t DESIGN MARK STAPLETON 817-446-1700 THE CELERIS GROUP, INC. 2000 E. LAMAR BLVD., STE. 550 ARLINGTON, TX 76006 TEAM 1. CURRENT ADA AND TAS REQUIREMENTS
2. 2015 IBC
3. 2012 IPC
4. 2006 IFC
5. 2012 IECC
6. 2012 IMC
7. 2014 NEC ALL WORK AND MATERIALS SHALL BE PERFORMED AND INSTALLED IN ACCORDANCE WITH THE CURRENT EDITIONS OF THE FOLLOWING CODES RELATED AMENDMENTS AS ADOPTED BY THE CITY: CO2 CO3.0 CO3.1 E02 E03 E04 E06 NO.1 TO 1 PROPERTY OWNER AT&T CONSTRUCTION MGR. AT&T CONSTRUCTION MCR. OVERALL SITE PLAN
DETAIL SITE PLAN
ELEVATION / ANTENNA ORIENTATION
ANTENNA CONFIGURATION
DETAILS ELECTRICAL
ELECTRICAL
ELECTRICAL
ELECTRICAL DETAILS GENERAL NOTES TITLE SHEET DESCRIPTION BUILD

FOR TH FOR THE LOCAL "ONE CALL CENTER"

DRAWN BY:
KDR
CHECKED BY:
ZG
DATE
08/21/17
PLOT SCALE

DRAWING NAME LITLE SHEET

0 SHEET No.

THE UTILITIES SHOWN HEREIN ARE FOR THE CONTRACTORS CONVENIENCE ONLY. THERE MAY BE OTHER UTILITIES NOT SHOWN ON THESE PLANS. THE ENGINEER/SURVEYOR ASSUMES NO RESPONSIBILITY FOR THE LOCATIONS SHOWN AND IT SHALL BE THE CONTRACTOR'S RESPONSIBILITY TO VERIFY ALL THE UTILITIES WITHIN THE LIMITS OF THE WORK ALL DAMAGE MADE TO THE EXISTING UTILITIES BY THE CONTRACTOR SHALL BE THE SOLE RESPONSIBILITY OF THE CONTRACTOR. IT'S THE LAW

THIS DRAWING IS COPYRIGHTED AND IS THE SOLE PROPERTY OF THE OWNER. IT IS PRODUCED SOLELY FOR USE BY THE OWNER AND ITS AFFILIATES. REPRODUCTION OR USE OF THIS DRAWING AND/OR THE INFORMATION CONTAINED IN IT IS FORBIDDEN WITHOUT THE WRITTEN PERMISSION OF THE OWNER. UNIVERSITY PARK WATER TOWER SITE NAME

AND

NG

CODES

1801 VALLEY VIEW LANE FARMERS BRANCH, TX 75234

at&t

L SPECIFICATIONS

2000 E. Lamar Blvd., Suite 550 Arlington, TX 76006 Office: 817.446.1700 Fax: 817.460.0677 TX Firm Reg. # F-13992

000000 2002-0

ONSULTING ENGINEERS

DELERIS PROJECT NO::

2

16-8534

S

I

E

INDEX

CONTRACTOR

CONTRACTOR

AT&T ENGINEER

D

PPROVALS

SNOISI ISSUED FOR CONSTRUCTION ISSUED FOR CONSTRUCTION ISSUED FOR CONSTRUCTION (FLERIS 08/14/17 08/03/17 08/21/17 DATE

REV

1203-2017

GENERAL REQUIREMENTS PURPOSE AND INTENT

- HE DRAWNG AND SPECFICHIONS ARE NIENDED TO BE FULLY EXPLANTORY AND SUPPLIERTARY, HOREUGY, SHOULD ANYTHING BE SHOWN, INDICATED, OR SPECIFED ON DAY AND NOT THE OTHER, IT SHAUL BE DONE THE GAME TO, SHOWN, INDICATED, OR SPECIFED IN BOTH, SHOULD THERE BE MAY DISCEPENACES BETWEEN REQUIREMENTS SHOWN IN BOTH, THE MORE STRINGENT REQUIREMENTS SHALL APPLY.
- THE INTENTION OF THE DOCUMENTS IS TO INCLUDE ALL LABOR AND MATERIALS REASONABLY NECESSARY FOR THE PROPER EXECUTION AND COMPLETION OF THE WORK AS STIPULATED IN THE CONTRACT.

COMPLICTS

- VERPY ALL MEASURENEWS AT THE SITE BEFORE GRDERING MATERIAL OR DONG ANY WORK, NO EXTRA CHARTE OR COMPENSATION WILL BE ALLONED DUE TO DIFFERENCES BETWEEN ACTUAL OBMESIONS OR DIMENSIONS SHOWN ON FUANS. SUBMIT NOTICE OF ANY DISCREPANCY IN DIMENSIONS OR OTHERWISE TO ATA! FOR RESOLUTION BEFORE PROCEEDING WITH THE WORK.
- NO PLEA OF IGNORANCE OF CONDITIONS THAT EXIST, OR OF DIFFICULTES OF CONDITIONS THAT HAY BE ENCOUNTEED, OR OF ANY OTHER RELEVANT MATE CONCERNING THE EXCLUTION OF THE WORK WILL BE ACCEPTED AS AN EXCUSE FOR ANY FAULURE OR OWNSION ON THE PART OF THE CONTRACTION TO THEFU EVER EXTALL OF LATE FEGURELIENTS OF THE CONSTRUCTION DOCUMENTS GOVERNING THE WORK.

CODES KEEP THE SITE FREE FROM ACCUMULATION OF WASTE AND RUBBISH CAUSED BY EMPLOYEES. AT THE COMPLETION OF THE WORK, REMONE ALL WASTE AND MON-CONSTRUCTION MATERIAL, INCLUDING ALL COMPLETIONSCOPE FOOLS, SCAFFOLDING, AND SURPLUS MATERIAL AND LEAVE SITE CLEAN AND READY FOR USE.

UCENSING CONTRACTOR SHALL BE RESPONSIBLE FOR FOLLOWING ALL LAWS, REGULATIONS, AND RALES PROMAUCATED BY FEDERAL SIME AND LOCAL AUTHORITIES WITH AURODICTION OVER THE SALIER THES RESPONSIBLITY IS IN EFFECT RECARDLESS ON WEATHER THE LAW, ORDINANCE. REGULATION OR RULE IS MEDITIONED IN THESE SPECIFICATIONS.

CONTRACTOR SHALL HAVE AND MAINTAIN A VALID CONTRACTOR'S LICENSE FOR THE LOCATION IN WHICH THE WORK IS TO BE PERFORMED. FOR JURSDICTIONS THAT LUCENSE MONDUM, TRADES, THE TRADELSMAN OR SUBCONTRACTOR PERFORMING THOSE TRADES SHALL BE LECTINED RESEARCH AND COMPLY WITH THE LUCENSING LWIS, PAY LICENSE FEES, AND SELECT AND INFORM SUBCONTRACTORS RECARDING THESE LAWS.

OSHA

FOLLOW ALL APPLICABLE RULES AND RECULATIONS OF THE OCCUPATIONAL SAFETY AND FEALTH AUMINISTRATIONS AND STATE LAWS BASED IN THE FEDERAL OCCUPATIONAL SAFETY AND HEALTH ACT. INESTER REGULATIONS INCLIDE, BUT ARE NOT INHEED TO, REGULATIONS OCCUPATIONS WITH TOWER CONSTRUCTION AND SAFETY, EXCAMINONS AND TREMCHING, AND WORK IN CONSTRUCTION AND EAPLOYEES AND SUBCONTRACTIORS WELA HARD HAITS AT ALL TIMES DUPING CONSTRUCTION.

PHOTOS AND

BUILDING PERMITS

PROVIDE PHOTOGRAPHIC EVIDENCE OF ALL FOUNDATION INSTALLATION, GROUNDING, REDICHING AFTER PLACEMENT OF UTILITIES PRIOR TO BACKFILL.

1. CONTRACTOR WILL SUBMIT CONSTRUCTION DOCUMENTS TO THE JURISDICTIONAL AUTHORITY FOR PLAN OFFICK AND REVEW, CONTRACTOR WILL SUBMIT LOCINING AND MORKMAN'S COMPENSATION, APPORATION TO THE UNRESOCITION AS REDURED TO GRIMN THE BUILDING PERMIT, CONTRACTOR SHALL CONCOUNTED AND SCHEDULE REQUIRED INSPECTIONS AND POST REQUIRED FERMITS AT THE JOB SITE. COMPLY WITH SPECTIFIC PROLECT REQUIRED NEEDEDS AND SUGGESTION MAKE BY BUILDING INSPECTION, AND INFORM CONSTRUCTION MANUELS OF ANY SUCH WORK THAT MAY BE REYORD THE SCOPE OF THE CONTRACT OR DEPORTED AT THE CONSTRUCTION DECOUNTES, ARE WILL AURIBRIES THE CONTRACTOR FOR FEES, FOR PLAN REVIEW, BUILDING PERMIT CONNECTIONS, AND INSPECTION. (INCLIDED IN THE BASE PROPEDSAL)

ZONING REGULATIONS AND CONDITIONAL USE PERMITS

CONTRACTOR WILL SUBMIT FOR AND OBTAIN AIT ZONING AND CONDITIONAL USE PERMITS, SOME USE PERMITS MAY HAVE SPECIFIC REQUIREMENTS FOR THE SITE RELATED TO CONSTRUCTION SUCH AS MOSE REQUIREMENT, OS. MODRY, ACCESS LIMITAIONS, FIG. THE CONSTRUCTION MANAGER WILL INFORM THE CONTRACTOR OF THESE REQUIREMENTS AT THE PRE-BID MEETING OR AS SHOWN IN THE CONSTRUCTION DOCUMENTS.

FAA PERMIT AND TOWER LIGHTING REFER TO CONSTRUCTION DOCUMENTS AND CONSTRUCTION MANAGER FOR FAX AND STATE LIGHTING REQUIREMENTS CONTRACTOR SHALL PROVIDE TEMPORARY FAX APPROVED LIGHTING LINTIL PERMANENT LIGHTING IS OPERATIONAL.

 If required, tower must be fenced, temporability of permanently within 24 hours of erection, do not allow the care accessing the tower area to remain open or interded any due for any reason, keep the cate closed and locked when not in use. TOWER SECURITY

SITE CONTROL

- THE CONTRACTOR IS CONPLETELY RESPONSBLE FOR CONTAINMENT OF SEDWENT AND COMPOU, OF EXOSON AT THE SITE. ANY DAMAGE TO ADJACENT OR DOWNSTREAM PROPERTIES WILL BE CORRECTED BY THE CONTRACTOR AT NO EXPENSE TO ANAT.
- THE CONTRACTOR IS TO MAINTAIN ADEQUATE DRAWNOE AT ALL TIMES, QO NOT ALLOW WATER TO STAMD OR POND, ANY DAMAGE TO STRUCTURES OR WORK ON THE SITE CAUSED BY UNADEQUATE LAWNIDMANGE OF DRAWNOE PROVISIONS WILL BE THE RESPONSIBILITY OF THE CONTRACTOR AND ANY COST ASSOCIATED WITH REPORTS FOR SUCH DAMAGE WILL BE AT THE CONTRACTOR'S EXPENSE.

- LIVESTOCK PROTECTION AL WASTE MATERIAL SHALL BE PROPERLY DISPOSED OF OFT—SITE OR DIRECTED BY THE CONSTRUCTION MANAGER AND IN ACCORDANCE WITH JURISDICTIONAL AUTHORITIES.

SITE PREPARATION

- TRIMMING OF EXISTING TREES AND VEGETATION AS REQUIRED FOR PROTECTION DURING CONSTRUCTION ACTIVITIES.
- CLEARING AND GRUBBING OF STUMPS, VEGETATION, DEBRIS. RUBBISH, DESIGNATED TREES AND SITE IMPROVEMENTS.
- TOPSOIL STRIPPING AND STOCKPILING.
- TEMPORARY EROSION CONTROL, SILTATION CONTROL, AND DUST CONTROL CONFORMING TO LOCAL REQUIREMENTS AS APPLICABLE.
- PROTECTION AND TEMPORARY RELOCATION, STORAGE AND RE-INSTALMTION OF EXISTING FENCING AND OTHER SITE IMPROVEMENTS SCHEDULED FOR REUSE.

- ROCK EXCAVATION WITHOUT BLASTING.
- QUALITY ASSURANCE REMOVAL AND LEGAL DISPOSAL OF EXCAVATED MATERIALS AS REQUIRED.
- UNDER STRUCTURES, BUILDING SLABS, PAVENERIS AND WALKWAYS WILL
 BEHAN A 55 PERCENT COMPACITION AT A MAXIMUM DRY BENSTIY AS
 DETERMINED BY ASTEN D-1557 OR WITHIN PLUS OF MINUS J. FERCENT OF
 OPTIMUM MOISTURE CONTENT.

- A. PLUS OR MINUS 1/2 INCH MEASURED WITH 10 FOOT STRAIGHTEDGE.

STRIPPING REMOVE ALL VEGETATION AND MATERALS AS REQUIRED, REMOVE STLAIPS COMPACEDY UNDER FOLVMANTIONS AND ROLOWAY, DISSIDES OF CLEARING AND GRUBBING OFF-SITE OR IN AN ON-SITE LOCATION APPROVED BY CONSTRUCTION MANAGER.

- COMMON EXCAVATION
- TEMPORARILY STOCKPILE ON-SITE EXCAVATION AT AN APPROVED LOCATION WITHIN THE WORK AREA UNTIL SITE GRADING IS COMPLETE. STOCKPILE SHALL NOT EXCEED 15 FEET IN HEIGHT

PROTECT AND SECURE LIVESTOCK. MAINTAIN AND SECURE EXISTING PERWETER FENCING AND OR GATED ENCLOSURES.

SCOPE OF WORK INCLUDES

- PROTECTION OF EXISTING TREES, VEGETATION AND LANDSCAPING MATERIALS WHICH MIGHT BE DAMAGED BY CONSTRUCTION ACTIVITIES

- TEMPORARY PROTECTION OF ADJACENT PROPERTY, STRUCTURES, BENCHMARKS AND MONUMENTS.
- REMOVAL AND LEGAL DISPOSAL OF CLEARED MATERIALS,
- PRODUCTS AND MATERIALS (AS APPROVED BY CONSTRUCTION MANAGER OR AS NOTED IN CONSTRUCTION DOCUMENTS.)
- MATERIALS USED FOR TREE PROTECTION, EROSION CONTROL, SILTATION CONTROL, AND DUST CONTROL

SCOPE OF WORK INCLUDES

3. EARTHWORK

- EXCAVATION, TRENCHBIG, FILLING, COMPACTION, AND GRADING STRUCTURES, SITE IMPROVEMENTS AND UTILITIES Ş
- MATERIALS FOR SUB-BASE, DRAIMGE, BACKFILL AND GRAVEL FOR SLABS, PAVEMENTS AND IMPROVEMENTS.

- SUPPLY OF ADDITIONAL MATERIALS FROM OFFSITE AS REQUIRED.

COMPACTION:

- GRADING TÖLERANCES OUTSIDE BUILDING LINES:
- UNDER PAVEMENTS, PLUS OR MINUS 1/2 INCH. LAWNS, UNPAVED AREAS AND WALKS PLUS OR MINUS I INCH
- GRADING TOLERANCES FOR FILL UNDER ALL CONCRETE APPLICATIONS:
- PRODUCTS AND MATERIALS (AS APPROVED BY CONSTRUCTION MANAGER OR AS NOTED IN CONSTRUCTION DOCUMENTS.)
- SUB-BASE MATERIAL: GRADED MIXTURE OF HATURAL OR CRUSHED GRAVEL, CRUSHED STORE OR SLAG, AND NATURAL SAND.
- WASHED MATERIAL, EVENLY GRADED MIXTURE OF CRUSHED STONE OR GRAVEL WITH 95 PERCENT PASSING A 1-1/2 INCH SEIVE.
- CRADINO MATERIAL WILL CONSIST OF SATISFACTORY IMINE OR IMPORTED SOIL MATERIALS FREE OF CLAY, ROCK OR GRAVEL HOT LABGER THAN 2 INCHES IN ANY DIRENSION DEBRIS, WASTE FROZEN MATERIALS AND OTHER LICHTOP FOR USE, MAPORTED MATERIALS SHALL HAVE A CLAY CONTENT NO MORE THAN 5 PERCENI.
- GRAVEL MATERIAL: EVENLY GRADED MIXTURE OF GRUSHED STONE OR GRAVEL WITH 95 PERCENT PASSING A 1-1/2 INCH SIEVE.
- CLEARING AND GRUBBING GEOTEXTILE FABRIC. AS PER CONSTRUCTION DOCUMENTS

STRP NOT LESS THAN 3 INCHES OF SOD AND TOPSON. FROM AREAS THAT WILL UNDERLAY GRIVEL, PAREMENT, NEW STRUCTURES OR NEW EMBANKMENTS STOCKPILE STRIPPING ON -STEE FOR RE-USE IN FINAL LANDSCLIPING.

- EXCAVATE TO DEPTH, LINES AND GRADES SHOWN ON THE PLANS OR AS OTHERWISE SPECIFIED
- LEGALLY DISPOSE OF EXCESS COMMON EXCAVATION OFF-SITE

- CONSTRUCT IN LIFTS OF NOT MORE THAN 12 INCHES IN LOOSE DEPTH, THE FULL WIDTH OF THE CROSS SECTION SHALL BE BROUGHT UP UNIFORMLY.
- MATERAL SHALL BE PLACED IN LAYERS AND SHALL BE MAE OFTINUM UDISTURE CONTENT BEFORE COLLING TO OBTAIN THE PRESCREED COLLINGTON, WETTING ON DERING BEFORE COLLING TO SHALM HE PRESCREED COLLINGTON MOSTURE CONTENT HEMOLOGICAL THE LAYER MAY BE REQUIRED, SUCH OPERATIONS SHALL BE INCLUDED IN THE LAYER MAY BE REQUIRED, SUCH OPERATIONS THAT OF TRAIN FROPER COLLINGTON IT IS THE CONTRACTOR'S RESPONSIBILITY TO UTILIZE MATERIAL WITH AN ACCEPTABLE MOSTURE CONTROL.
- COMPACTOR SHALL BE RESPONSIBLE FOR THE STABILITY OF EMBANKMENTS AND THE REPLACEMENT OF ANY PORTION WHICH HAS BECOME DISPLACED DUE TO THE CONTRACTOR'S OPERATIONS.
- DO NOT PLACE FROZEN MATERIAL IN THE EUSANKWENT AND DO NOT PLACE EMBANKWENT MATERIAL UPON FROZEN MATERIAL
- START LAYERS IN THE DEEPEST PORTION OF THE FILL AND AS PLACEMENT PROGRESSES, CONSTRUCT LAYERS APPROXIMATELY PARALLEL TO THE FINISHED GRADE LINE.
- ROUTE EQUIPMENT, BOTH LOADED AND EMPTY, OVER THE FULL WIDTH OF EMBANKMENT TO ENSURE UNFORMITY OF MATERIAL PLACEMENT.
- COMPACT EMBANWICHT UNDERLYING NEW GOWEL PAVING, FLOOR SLABS AND STRUCTURES TO A 95 PERCENT COMPACTION AT A MAXIMUM ORY DEJISTY AS DETERMINED BY ASTUD —1557, OR MITHAIN PLUS OR MINUS 3 PERCENT OF OPTIMUM MOISTURE CONTENT. COMPACT NON-STRUCTURAL AREA EMBANKALPHIS TO A MINIMUM OF 90 PERCENT OF ASTM D—1557.

SITE GRADING

- USING ON-SITE EXCAVATION WATERIALS, SHAPE TRIA, TRUSH AND COMPACT SURFACE AREAS TO CONFORM TO THE LINES. GRADES AND CROSS SECTIONS SHOWN ON THE DRAWNINGS OR AS DESIGNATED BY THE CONSTRUCTION MANAGER
- GRADE SURFACES TO DRAIN AND ELIMINATE ANY PONDING OR EROSION
- COMPACT AREAS OF UNDERLYING NEW CRAVEL, PAWIKG, FLOOR SLAES AND STRUCTURES TO A 95 PERCENT COMPACTION AT A MANIMUM ORY DENGITY AS DETERMINED BY THE ASTM 0—1557 OR WITHIN PLUS OR MINUS 3 PERCENT OF DITHUM MOSTURE CONTENT. ELIMINATE WHEEL RUTS BY REGRADING.
- CONSTRUCT FINISHED SURFACE OF SITE GRADING AREAS WITHIN ONE INCH FROM SPECIFIED GRADE

SUBGRADE PREPARATION

- SHAPE TOP OF SUBGRADE TO THE LINES AND GRADES SHOWN ON THE DRAWINGS MAINTAIN TOP OF SUBGRADE IN A FREE-DRAINING CONDITION.
- DO NOT STOCKFILE MATERIALS ON TOP OF SUBBRADE UNLESS AUTHORIZED BY CONSTRUCTION MANAGER.
- COMPACT THE TOP 12 INCHES OF SUBGRADE TO A 95 PERCENT COMPACTION AT A MAXIMUM DRY DENSITY AS DETERMINED BY ASTM D-1557 OR WITHIN PLUS OR MINUS 3 PERCENT OF THE OPTIMUM MOSTURE CONTENT
- CONSTRUCT TOP OF SUBGRADE WITHIN ONE INCH OF ESTABLISHED GRADE AND CROSS-SECTION.

GEOTEXTILE FABRIC

LAY GEOTEXTILE FABRIC OVER COMPACTED SUBGRADE IN THE COMPOUND AREA AND LENGTH OF ROAD (WHEN REQUIRED). LAP ALL JOINTS TO A MINIMUM OF 36 INCHES UNDER

GRAVEL SURFACING CONSTRUCT GRANEL SURFACHIG AREAS USING CRUSHED AGGREGATE BASE AND FAIRH COURSES AS SPECIFED OF CONSTRUCTION MANAGER. SPREAD GRAVEL AND RAKE TO OBTAIN A UNITORAL SURFACE AREA

LANDSCAPING

FURNISH, INSTALL AND MAINTAIN LANDSCAPE WORK AS SHOWN AND OR REQUIRED WITHIN THE CONSTRUCTION DOCUMENTS OR AS SPECIFED IN THE CONSTRUCTION SPECIFICATIONS.

CONCRETE FORM WORK

- CHANTER EXPOSED EDGES OF ALL TOWER FOUNDATION SHALL RECEIVE A 3/4" X 3 DEGREE CHANTER, OTHER EXPOSED EDGES SHALL RECEIVE A TOOLED RADIUS FINIS UPON COMPLETION, REMOVE ALL FORMS INCLUDING THOSE CONCEALED OR BURIED. RETER TO STRUCTURAL DRAWINGS FOR ADDITIONAL REQUIREMENTS FORMS: SMOOTH AND FREE OF SURFACE IRREGULARITIES: UTILIZE FORM RELEASE AGENTS.

CONSTRUCT EMBANKMENT TO THE UNES AND GRADE SHOWN ON THE DRAWINGS.

5. GENERAL NOTES:

REVISIONS

ISSUED FOR CONSTRUCTION ISSUED FOR CONSTRUCTION

08/14/17 08/21/17

ISSUED FOR CONSTRUCTION

08/03/17

- CONSTRUCT EMBANKMENT FROM ON-SITE EXCAVATION MATERIALS WHEN SUITABLE. USE IMPORTED BACKFILL ONLY AFTER AVAILABLE ON-SITE EXCAVATION MATERIALS HAVE BEEN USED.
- THE PLANS SHOW SOME KNOW SUBSURFACE STRUCT
 AND/OR JITAINES SELEPED TO EXIST IN THE WORKIN
 WACH MAY WART FROM THE LOCATIONS MIGOLATED. IN
 WARNED THAT THE EXACT OR EXEL METROCAUTE, AND
 SUBSURFACE STRUCTURES ANOVA UTILITIES IN THE
 NOT BE SHOWN AND IT SHALL BE HIS RESPONSIBILIT
 IN EXCHANION MAY WORK, 48 HOURS BETORE YOU I
 UTILITY LOCATOR COMPANY. ACE STRUCTURES ABOVE GROUND STRUCTURES.

 THE WORKING AREA, EXACT LOCATION OF

 NORTHED, IN PARTICULAR, THE CONTRACTOR IS

 ROWINGTE LOCATIONS OF SUCH PRELIMES,

 RESONANTE LOCATIONS OF SUCH PRELIMES,

 RESONANTE LOCATIONS OF SUCH PRELIMES,

 REFORE YOU DIG, DRILL OR BLAST CALL LOCAL

 SEFORE YOU DIG, DRILL OR BLAST CALL LOCAL

THE CONTRACTOR IS RESPONSIBLE FOR MAINTAINING A REAT AND ORDERLY SITE, YARD AND GEORIUMS. CONTRACTOR SHALL REMORE AND DEPOSIT OFF SITE ALL RUBBISH, WASTE MATERIALS, LITTER AND ALL FORCION SUBSTANCES. REMORE PEROCLAMINAL SPILLS. STANKS AND OTHER FORCION DEPOSITS. PARK GROUNDS TO A SMOOTH CEPH-TEXTURED SURFACE.

IT IS THE CONTRACTOR'S RESPONSIBILITY TO EXAMINE ALL PLAN SHEETS AND SPECIFICATIONS AND COORDINATE HIS WORK WITH THE WORK OF ALL OTHER CONTRACTORS TO ENSURE THAT WORK PROGRESSION IS NOT INTERRUPTED.

- THE OWNER OR OWNERS'S REPRESENTATIVE CONDITIONS THAT VARY FROM THOSE SHOWN SHALL NOT VARY FROM THE PLANS WITHOUT OWNER OR THE OWNER'S REPRESENTATIVE. SHALL BE NOTIFIED IN WRITING OF ANY ON THE PLANS. THE CONTRACTOR'S WORK THE EXPRESSED APPROVAL OF THE
- THE COMPACTOR IS INSTRUCTED TO COOPERATE WITH ANY AND ALL OTHER COMPACTORS PERFORMING WORK ON THIS JOB STIE DURING THE PERFORMANCE OF THIS CONTRACT
- THE CONTRACTOR SHALL RESTORE ALL DAMASED, PUBLIC OR PRIVATE, PROPERTY TO AT LEAST AS GOOD OF CONDITION AS BEFORE DISTURBED AS DETERMINED BY THE OWNER OR DWINER'S REPRESENTATIVE

DELERIS PROJECT NO.:

16-8534

H E E

- THE CONTRACTOR SHALL COMPLY WITH ALL PROPERTY LINE MONUMENTATION ANY AS JUDGED BY THE OWNER OR OWNER'S REQUIRED PERMITS.
- THE CONTRACTOR SHALL PROTECT EXISTING MONUMENTATION DISTURBED OR DESTROYED, REPRESENTATIVE SHALL BE REPLACED.
- CONTRACTOR SHALL BE RESPONSIBLE FOR DEWALERING AND THE MAINTENANCE OF SURFACE DRAINAGE DURING THE COURSE OF WORK. ALL TRENCH EXCAVATION AND ANY REQUIRED SHEETING AND SHORING SHALL BE DONE IN ACCORDANCE WITH OSHA REGULATIONS FOR CONSTRUCTION.
- ALL UTILITY WORK HAVOLVING CONNECTIONS COORDINATED WITH THE DWNER OR OWNER'S BEFORE EACH AND EVERY CONNECTION TO I TO EXISTING SYSTEMS SHALL BE S REPRESENTATIVE AND THE UTILITY OWNER EXISTING SYSTEMS IS MADE.

2000 E. Lamar Blvd., Suite 550 Arlington, TX 76006 Office: 817.446.1700 Fax: 817.460.0677

TX Firm Reg. # F-13992

CONTRACTOR TO GRADE ALL AREAS OF THE THE BUILDING OR EQUIPMENT FAD AND THE SHE TO PROVIDE POSITIVE DRAINAGE AWAY FROM TOWER. ALL SITE FILL SHALL MEET SELECTED FILL ST OWNER'S REPRESENTATIVE ON THE DRAWINGS MAINTAIN FLOW FOR ALL EXISTING UTILITIES.

ANDARDS AS DEFINED BY THE OWNER OR OR GEOTECHNICAL REPORT RECOMMENDATIONS

- IF NECESSARY, THE CONIFACTOR IS RESPONSIBLE FOR REPARING AND REGRADING ROADWAY AND ANY DISTURBED AREAS FOLLOWING INSTALLATION OF UTILITIES.
- WATER AND SEWER SERVICES ARE NOT REQUIRED FOR THIS DEVELOPMENT ON TOWER
- NO COMMERCIAL MESSAGES TO BE DISPLAYED
- THE CONTRACTOR SHALL FURNISH AND INSTALL ALL WATERALS UNLESS NOTED.
 THE CONTRACTOR SHALL FURNISH SANITARY FACILITIES FOR PERSONNEL DURING CONSTRUCTION.
- ALL PEDESTAL PENETRATIONS SHALL BE APPROVED PRIOR TO CUTTING \not DRILLING BY THE TANK MANUF. LANDMARK STRUCTURES 8177-439-8888 ALL PENETRATIONS SHALL BE PERMANENTLY PREVENT BUGS AND VERMIN FROM ENTERING sealed following cable installation to the tower.
- ALL CABLES SHALL BE LABELED AT ENTRY AND EXIT POINTS ON THE PEDESTAL, LABEL TO BE PERMANENT,
- 24. ALL CABLES SHALL BE RUN PARALLEL AND PLUMB TO STRUCTURAL NEMBERS
- CABLES AND EDUP. MAY NOT BE ATTACHED TO LADDERS, STANDOFFS, HANDRAILS, PIPING RUNS WALKWAYS OR OTHER WATER TOWER FACILITIES.
- 25, GROUNDING BUS FOR CELLULAR COUR SHALL OR ANY EXPOSED TOWER STEEL NOT BE ATTACHED TO TOWER GROUND LOOP





at&t





THIS DRAWING IS COPYRIGHTED AND IS THE SOLE PROPERTY OF THE OWNER. IT IS PRODUCED SOLELY FOR USE BY THE OWNER AND ITS AFFILIATES, REPRODUCTION OR USE OF THIS DRAWING AND/OR THE INFORMATION CONTAINED IN IT IS FORBIDDEN WITHOUT THE WRITTEN PERMISSION OF THE OWNER. JNIVERSITY PARK WATER TOWER NAME 1801 VALLEY VIEW LANE FARMERS BRANCH, TX 75234

GENERAL NOTES DRAWN BY:
KDR
CHECKED BY:
ZG
DATE
1.
PLOT SCALE

NOI

OVERALL SITE PLAN SCALE: (34" x 22") 1"-30"-0" SCALE: (17" x 11") 1"-60"-0" SCALE: (7EET) SCALE: (FEET) 0. 30 60 90 120	(a) Artic Comprise Company (company of the company	WEST NORTHWEST HWY WEST NORTHWEST HWY	
ZHENJING GUO ZHENJING GUO THIS REAMING IS COMPICUTED AND IS THE SOL			NORTH SAN NORTH
DRAWN BY: KDR KDR CHECKED BY: ZG DATE 08/03/17 PLOT SCALE 1:2 PRAWNIG NAME OVERALL SITE PLAN SHEET NO.	SITE NAME WATER TOWER 1801 VALLEY VIEW LANE FARMERS BRANCH, TX 75234	CELERIS PROJECT NO.: 16-8534 CELERIS PROJECT NO.: 16-8534 CO 1 5 U L 7 I II C III	REDOEN WITHOUT THE WRITTEN PERMISSION OF THE OWNER O

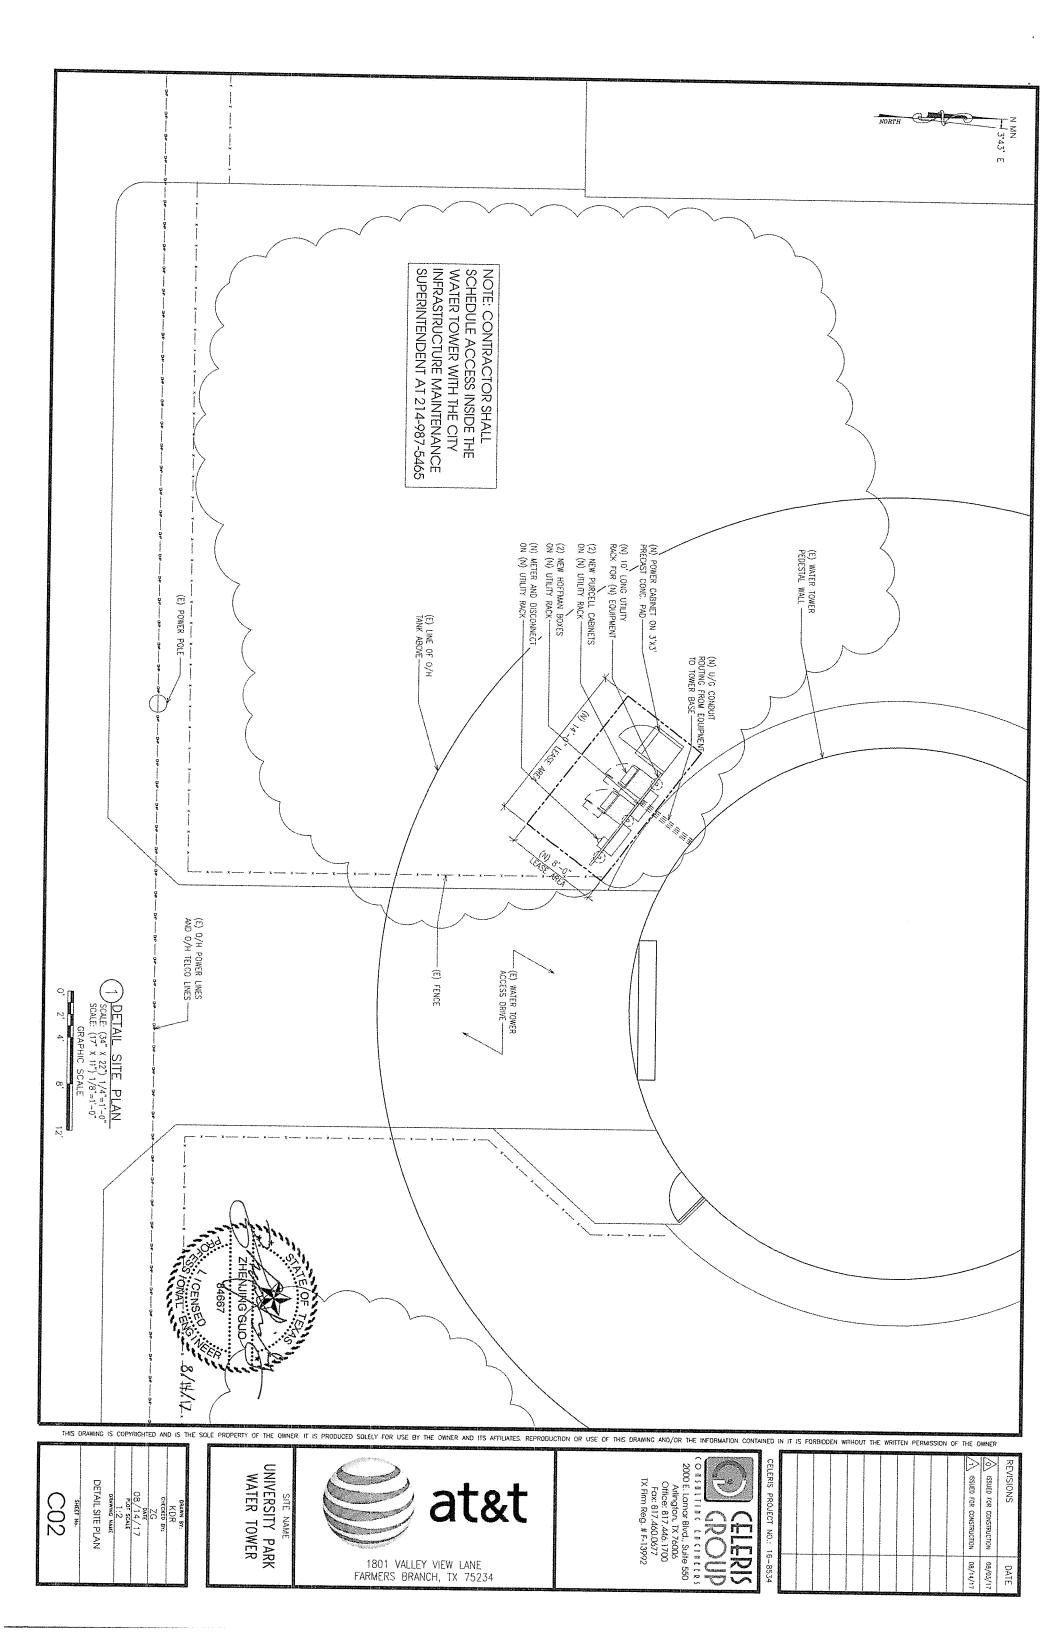

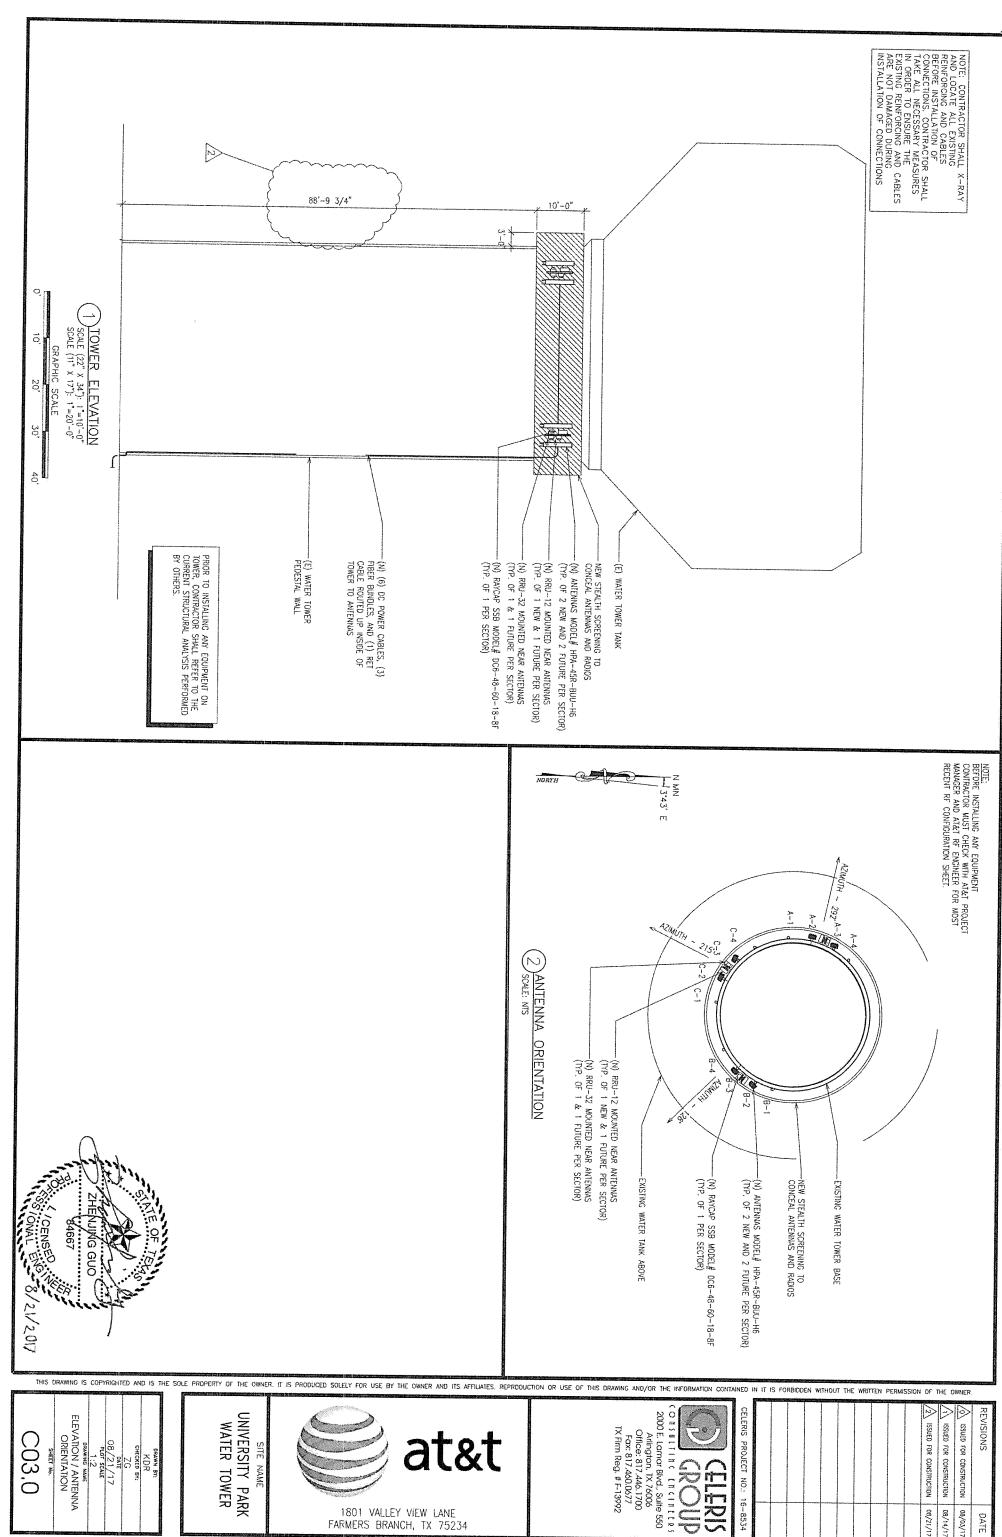

DRAWING NAME
ELEVATION / ANTENNA
ORIENTATION C03.0 CHECKED BY:

ZG
DATE

08/21/17
PLOT SCALE

UNIVERSITY PARK WATER TOWER



1801 VALLEY VIEW LANE

FARMERS BRANCH, TX 75234

2000 E. Lamor Bivd., Suite 550 Arlington, TX 75006 Office: 817.446.1700 Fax: 817.440.0677 TX Firm Reg. # F-13992

CELERIS PROJECT NO.: 16-8534

		o constantiti	ATT-COMMAN	and a second	Total or the	

08/14/17 08/03/17

DATE

ANTENNA NUMBER NOTE 2 G-1 8-4 CABLE NOTE B-3 8-2 NOTE 1 8-1 A-4 A-2 A-3 A-1 RD/RD/WH/WH RD/WH RD/RD/WH/WH RD/WH RD/OR/WH RD/OR RO/RO RD/OR RD/OR/WH RO/RO RD RD/WH RD/WH RD/RD/WH/WH RD/RD/WH/WH RD/WH RD/RD/WH/WH RD/RD/WH/WH RD/WH RD/OR RO/RO RD/OR/WH COAX COLOR TYPE OF CABLE DC POWER RET CABLE FIBER MAKE 8 8 8 8 8 8 ANTENNA INFO. HPA-45R-BUU-H6 HPA-45R-BUU-H6 HPA-45R-BUU-H6 HPA-45R-BUU-H6 HPA-45R-BUU-H6 HPA-45R-BUU-H6 MODEL CABLE INFO. 3/4" 1/2" AZIMUTH 215 215 128 128 292 292 RAD CENTER 90, 90 90' 90' 90° 90' ELEC: MECH.
DOWNTILT DOWNTILT o, Ó, Ċ O. 700/850 o. Ç γrg 0 Ç o Q တ Çĸĭ DOWNTILT DOWNTILT ó Ç O, Q Ċ ALPHA 160'±, BETA 130'±, GAMMA 110'± 1900/HB ALPHA 160'±, BETA 130'±, GAMMA 110'± Ç o. Ó o, Q LENGTH SIZE SEE CABLE NOTES COAX INFO. LENGTH

1) ANTENNA CONFIGURATION SCALE NTS

CONTRACTOR TO PROVIDE AS-BUILTS FOR THE LENGTH OF CABLES UPON COMPLETION OF INSTALLATION.


2. TYPES AND SIZES OF THE ANTENNA CABLES ARE BASED ON THE ESTIMATED LENGTH OF THE CABLES. CONTRACTOR TO VERIFY ALL ACTUAL LENGTHS IN THE FIELD PRIOR TO INSTALLATION AND NOTIFY THE AT&T FIELD ENGINEER FOR VERIFICATION OF SIZES OF CABLES.

NOTES: 1. LENGTHS POSED ON THIS CHART ARE ESTIMATED FROM AVAILABLE INFORMATION

3/8

ALPHA 160'±, BETA 130'±, GAMAMA 110'±

NOTE 3

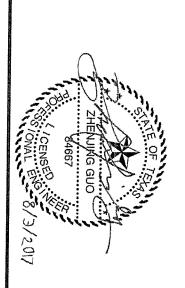

SOLE PROPERTY OF THE OWNER, IT IS PRODUCED SOLELY FOR USE BY THE OWNER AND ITS AFFILIATES. REPRODUCTION OR USE OF THIS DRAWING AND/OR THE INFORMATION CONTAINED IN IT IS FORBIDDEN WITHOUT THE WRITTEN PERMISSION OF THE OWNER.

THIS	DRAWING	IS	COPY	RIGHT	ED	AN	0 1	S TH	Œ
C03.1	SHEET NO.	DRAWING NAME	PLOT SCALE 1:2	08/03/17	ZG		KDR	DRAWN BY:	


	_	200	
₹	\leq	on the same	
WATER	UNIVERSIT	71S	
70	S	3	
ō	≺	SITE NAME	
TOWER	ρŅ		
70	PARK		





1801 VALLEY VIEW LANE FARMERS BRANCH, TX 75234

ISSUED FOR CONSTRUCTION 08/03/17

VISIONS

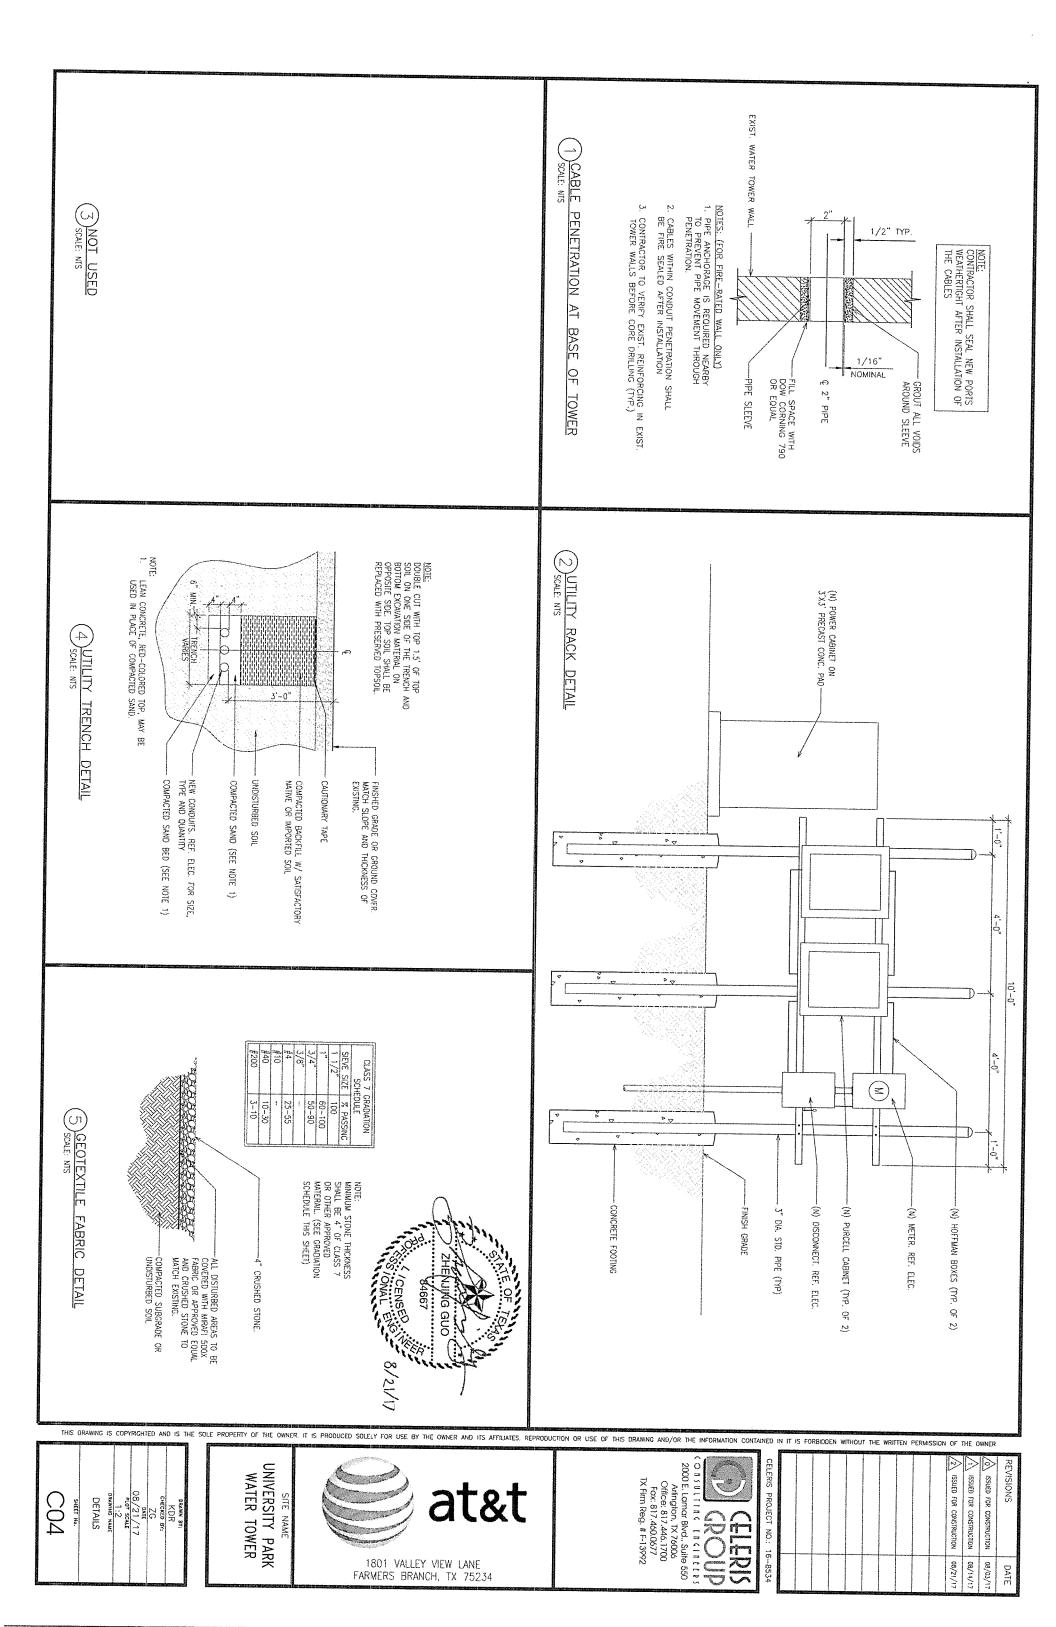

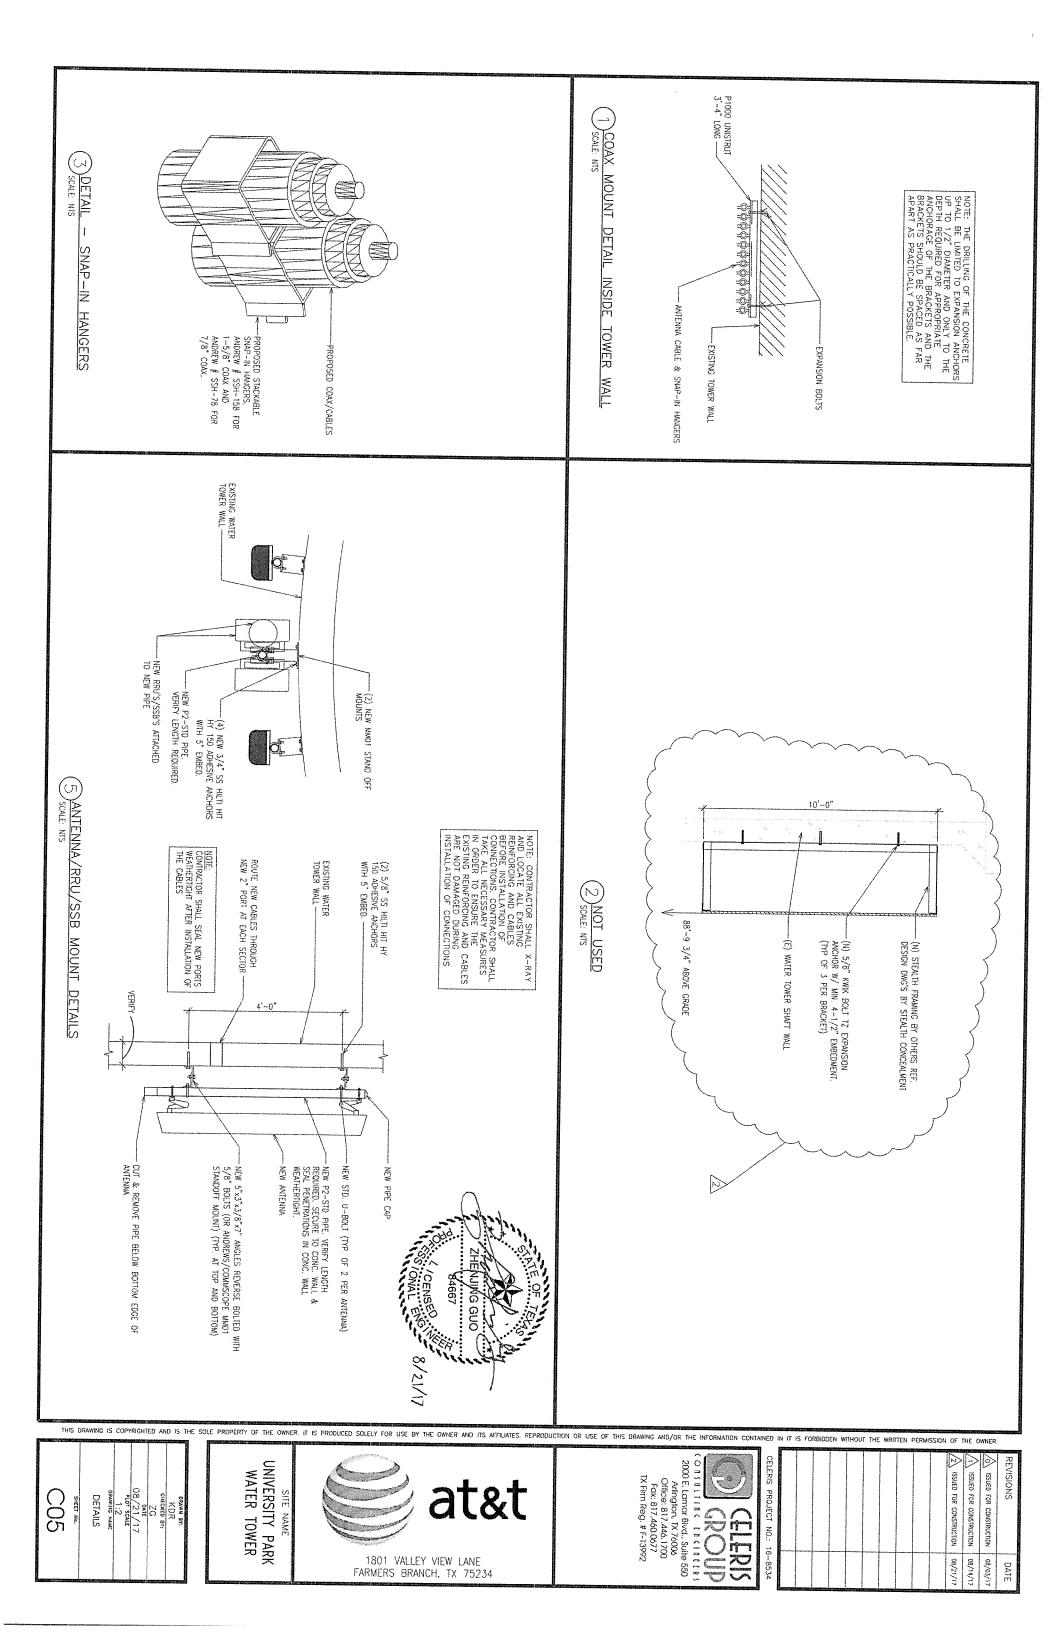

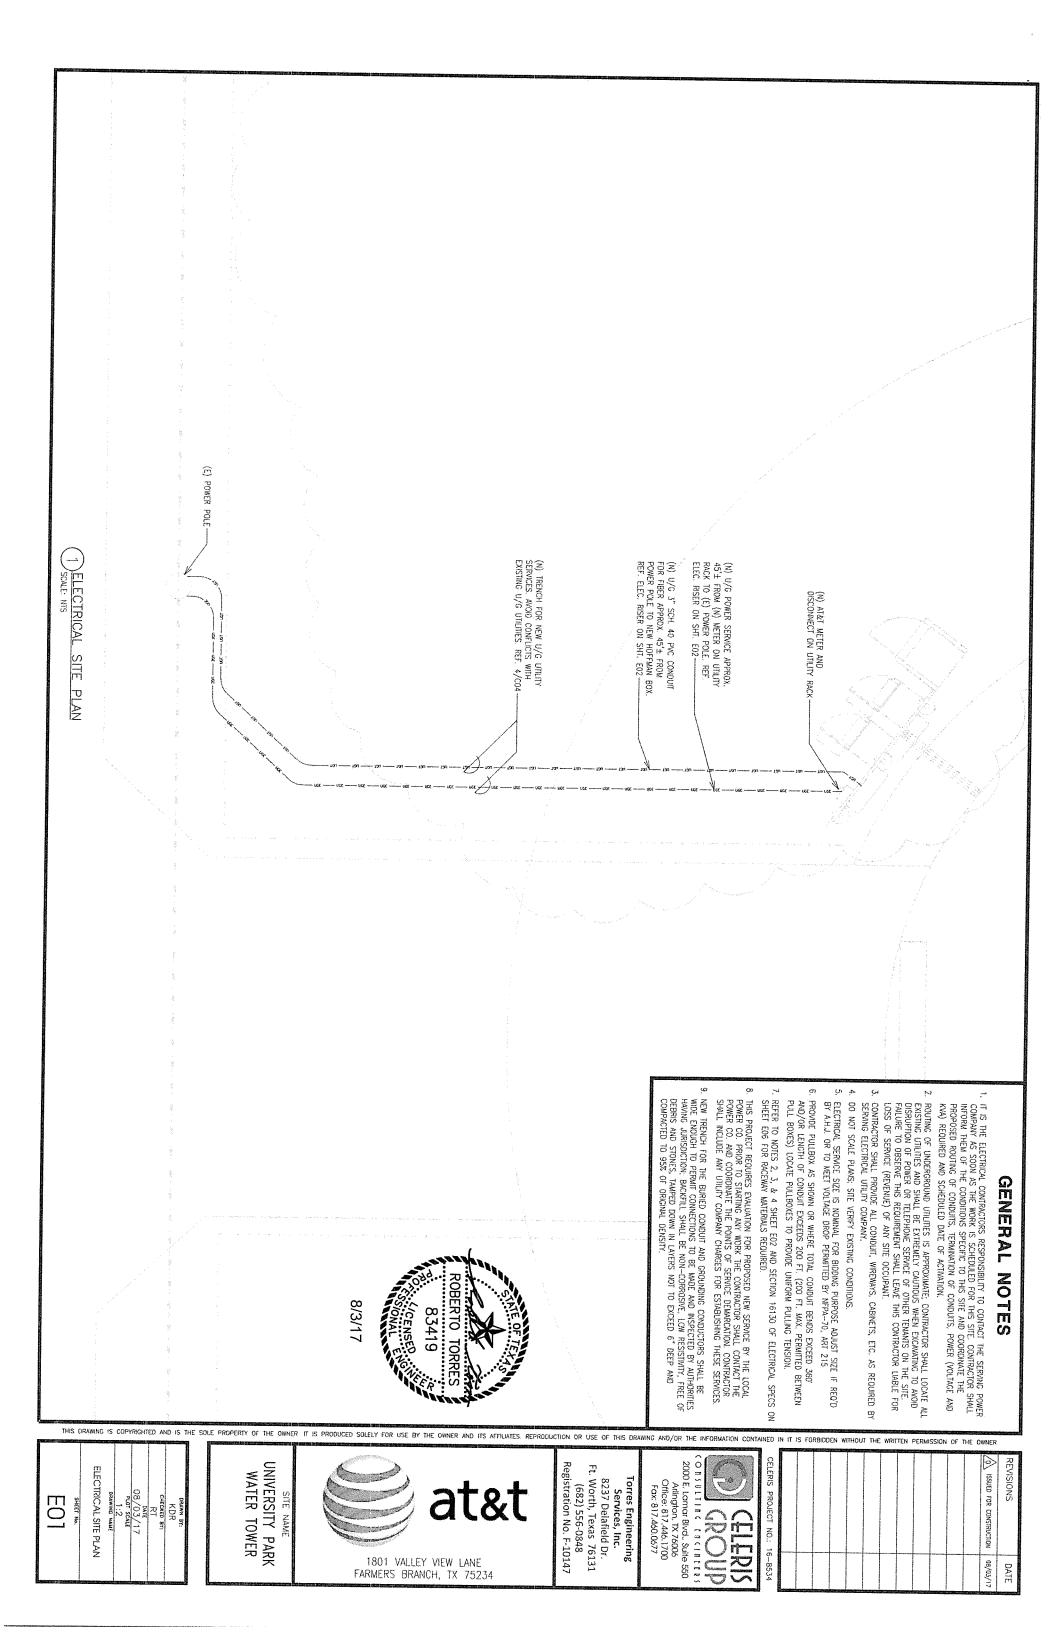

NOTES: BY NEW POWER CABINET REFERENCE

REFER TO GROUND ROD WITH ACCESS AREA DETAIL 2/E04.

4 NEW AT&T 200AMP 240V 103W METER SOCKET IN EXISTING METER BASE BY ELECTRIC SERVICE PROVIDER.

5) NOT USED

 \bigcirc (6) 2" SCH. 40 PVC CONDUIT WITH 3-3/0, 1#2G TYPE THWN FROM GENERATOR SLAB TO AUTOMATIC TRANSFER SWITCH FOR POWER.

5/8" DIAMETER X 10' COPPER CLAD GROUND RODS. DRIVE TOP TO 18" BELOW SURFACE. INSTALL GROUND ROD INSPECTION PORT (RE: 2/E04). GROUNDING ELECTRODE CONDUCTOR (#1/0 CU) IN 3/4" PROTECTIVE CONDUIT

 \bigcirc \bigcirc NOT USED

(10) NOT USED \equiv

(13)

 \overline{z} PROVIDE 3-3/0, 1#2G TYPE THWN IN 2" CONDUIT (INC ABOVE GRADE, SCHED. 40 PVC BELOW GRADE). NOT USED

(<u>z</u> $3/4^{\circ}$ SCH. 40 PVC CONDUIT FROM GENERATOR SLAB TO 1C LOCATION FOR ALARMING PURPOSES (ROUTE TO TELCO ENTRY AT SHELTER),

3/4" SCH. 40 PVC CONDUIT FROM GENERATOR SLAB 10 AUTOMATIC TRANSFER SWITCH FOR 2 WIRE START (ROUTE CONDUIT TO NEW ATS ON SHELTER).

29	17	5	ē	=			1 0	n c	ı .	-	š	NE 120	
	←	20	20	20	6	3 6	3 2	3 6	3 6	70	NO TRIP**	1S/PH)/240V /A	PANEL
SPACE	SPACE U	RECTIFIER #8	RECTIFIER #7	RECTIFIER #6	RECIGIEK #5	NECTIFIEN #4	NECHELEN #3	ACCIMEN #2	Section #2	RECTIFIED #1		VOLIS/PHASE/WIRE 120/240V. 1 PH. 3W. NEMA	7
											SERVES	PANEL SIZE & TYPE 200A*	TOTAL CONNECTED LOAD = 20 KVA
			2400		2400		2400		2400	3	⊳	MAIN TYPE 200A MCB	ED LOAD =
		2400		2400		2400		2400			В		20 KVA
					>	1				1	z	*CABINET INSIDE INTERSECT	
					2500		2500		1200		A	POWER	
				2500		2500		720		,	B	NN. SC CAP SAVAIL FAULT CURRENT FROM POWER COMPANY	
		_			_	E				Ţ;	z		
SPACE				(A/C UNIT #2	-	A/C UNIT #1	RECEPTACLES	INTERIOR LIGHTS	ÚL.	253	NOTES: SERVICE ENTRANCE RATED AS REQUIRED	
	-									(V.L.)	SEBVES	FED FROM INTERSECT: REFER TO ELECTRICAL RISER DIAGRAM	
				30 12	25	30	25	20	20	JAIT NO	70(0.0	INTERSE ELECTRIC	
5		6	4	72	7 0	œ	6	4	2	1		¥9	

SYMBOLS LIST AN	SYMBOLS LIST AND ABBREVIATIONS
	DIRECT BURIED BARE GROUND WIRE
derman security security security	UNDERGROUND ELECTRICAL CONDUIT AND FEEDER
Address C. C. Communic. C. C. Vancoroc. C. C. Specimen	UNDERGROUND TELEPHONE CO. CONDUIT TO TELCO DEMARK POINT
-	GROUNDING RING
	CONNECTION (CADWELD OR EXOTHERMIC WELD TO STRUCTURE OR DEVICE
(*)	GROUNDING PORT, SEE DETAIL 2 SHEET EO4 GROUNDING PLAN
	CONNECTION TO GROUND RING OR GROUND ROD. EXOTHERMIC WELD OR AS REQUIRED BY AUTHORITY HAVING JURISDICTION
	PULL BOX NOMINAL 24"X24"X36" DEEP (WITH TRAFFIC LID WHERE VEHICULAR TRAFFIC IS LIKELY)
×-	INDICATES 2 HOT, 1 NEUTRAL, & 1 GROUND IN CONDUIT
A.H.J.	AUTHORITY HAVING JURISDICTION
CM	CONSTRUCTION MANAGER OR AGENT FOR AT&T

				INTERSECT POWER COMPANY	1 POWE	R COMPA		RATED AS REQUIRED RISER DIAGRAM	ISER DIAGRA	₹.
	SERVES	Þ	œ	N	Α	В	z	SERVES	S	골
ECTIFIER #1		2400			1200			INTERIOR LIGHTS		2
ECTIFIER #2			2400			720	1	RECEPTACLES		2
ECTIFIER #3		2400	-		2500		1	A/C UNIT #1		임
ECTIFIER #4			2400	4		2500	4			\mathcal{L}_{n}
ECTIFIER #5		2400		><	2500		+	A/C UNIT #2		28
CTIFIER #6			2400			2500	\Rightarrow			\mathcal{K}
CTIFIER #7		2400	***************************************				\Rightarrow	•		
CTIFIER #8			2400				7			
ACE U										
ACE								SPACE		
LIST AN	LIST AND ABBREVIATIONS	SNC								
-	DIRECT BURIED BARE GROUND WIRE	BARE (ROUN	D WIRE						
1	UNDERGROUND ELECTRICAL CONDUIT AND FEEDER	ELECTRI	ICAL C	ONDUIT	AND F	EDER				
	UNDERGROUND TELEPHONE CO. CONDUIT TO TELCO DEMARK POINT	TELEPH	ONE C	O. CON	DUIT TO	TELCO	DEMA	RK POINT		
	GROUNDING RING	a a								

GENERAL NOTES:

REVISIONS

DATE

ISSUED FOR CONSTRUCTION

08/03/17

- 1. REFER TO GENERAL NOTES, SHEET E01 FOR SITE COORDINATION REQUIREMENTS.
- COORDINATE WITH CONSTRUCTION MANAGER TO OBTAIN CURRENT APPLICABLE TOWER GROUNDING REQUIREMENTS FROM AT&T WIRELESS.
- USE TINNED COPPER (SOLID) FOR EXTERIOR GROUNDING (TYPICALLY #2 OR AS NOTED); USE STRANDED COPPER WIRE FOR GROUNDING WHERE NOT EXPOSED AND NOT IN CONTACT WITH EARTH (SEE NOTE 4 BELOW) BURY ALL BARE GROUND WIRES 30" BELOW GRADE, LOCATE NO CLOSER THAN 3' FROM FENCE O 24" FROM FOUNDATIONS. SLEEVE ALL FOUNDATIONS, CADWELD AND TEST CONDUCTIVITY OF ALL GROUND TIE POINTS.

유

TO MINIMIZE LIGHTNING DAMAGE, NO SHARP BENDS PERMITTED IN ANY WIRING, INCLUDING GROUNDING.

O)

Ċu

7. PRIME AND EPOXY PAINT ALL EXPOSED CONDUIT TO MATCH EXTERIOR OF EQUIPMENT BUILDING. GROUND RODS TO BE COPPER CLAD STEEL 5/8" DIAMETER X 10"-Q" LONG WITH TOPS BURIED 18" MINIMUM BELOW FINISHED GRADE, CADWELD TO GROUND RING. RODS SHALL BE SPACED 10" TO 15" ON CENTER ALONG THE GROUND RING.

ĺα

ELECTRICAL CONTRACTOR SHALL CONNECT EXTERIOR GROUNDING WIRE TO GROUND RING INSIDE EQUIPMENT BUILDING. TOWER CONTRACTOR SHALL MAKE ALL ABOVE GROUND CONNECTIONS TO TOWER BUS BARS, AND WAVEGUIDE BRIDGES AT TIME OF CONNECTION TO TOWER. ONE CONNECTION TO THE TOWER BASE SHALL BE A MECHANICAL TYPE, ALL OTHERS SHALL BE CADWELDED. (SEE NOTE 10 BELOW)

CWIL CONSTRUCTION CONTRACTOR SHALL BURY ALL GROUND RINGS, CIVIL CONSTRUCTION CONTRACTOR SHALL CADWELD PIGTAILS FOR ALL ABOVE GROUND CONNECTIONS AT TIME OF GROUND RINGS INSTALLATION.

PROTECT AND SUPPORT ALL WIRING SUCH THAT IT WILL NOT VIBRATE AGAINST OTHER METALLIC OBJECTS AND SUCH THAT THERE ARE NO SHARP BENDS (NOMINAL RADIUS 6" MIN.) CADWELD ALL CONNECTIONS WHERE POSSIBLE AT TOWER OR LOCATION OF MULTIPLE CADWELD CONNECTIONS, IT MAY BE PERMISSIBLE TO MECHANICALLY BOLT A BUSS BAR TO GROUND OR TO SUPPORT STRUCTURE.

0



8/3/17

THIS DRAWING IS COPYRIGHTED AND IS THE SOLE PROPERTY OF THE OWNER! IT IS ELECTRICAL RISER DIAGRAM UNIVERSITY PARK WATER TOWER DRAWN BY:
KDR
CHECKED BY:
RT
DATE
DATE
OB/03/17
PLOT SCALE
1:2
DRAWNG NAME SITE NAME

ROUTE NEW 2* CONDUIT UP POWER POLE PROVIDE STAND OFF BRACKETS.

PROVIDE NYLON PULL STRINGS ON ALL EMPTY CONDUITS

INSTALL ALL CONDUITS & EQUIPMENT AS SPECIFIED BY POWER CO. & TELE. CO.

VERIFY ALL EXISTING UNDERGROUND. UTILITIES BEFORE TRENCHING. ELECTRICAL CONTRACTOR SHALL CONTACT POWER CO. & TELE. CO. & VERIFY EXACT ROUTING/SIZES & CONDITIONS BEFORE TRENCHING.

1) RISER DIAGRAM

E02

36" MIN.

 Θ

(7)

(2)

(E)

WIRE FOR CONNECTION
BY THE POWER CO.

NOTES:

-EXISTING O/H TELCO LINES

EXISTING 0/H POWER LINES

3	PR	ODL	JCEE)))	OLE	LY :	FOR	USE	BY		OWNE	R AND	(IS	AFFIL	IATE	S. :
									7	(a	t	. (<u>Ş</u>		

1801 VALLEY VIEW LANE


FARMERS BRANCH, TX 75234

8237 Delafield Dr. Ft. Worth, Texas 76131 (682) 556-0848 Registration No. F-10147

Torres Engineering Services, Inc.

2000 E. Lamar Blvd., Sulte 550 Arlington, TX 76006 Office: 817.446.1700 Fax: 817.460.0677

REPRODUCTION OR USE OF THIS DRAWING AND/OR THE INFORMATION CONTAINED IN IT IS FORBIDDEN WITHOUT THE WRITTEN PERMISSION OF THE OWNER CELERIS PROJECT NO.: 16-8534

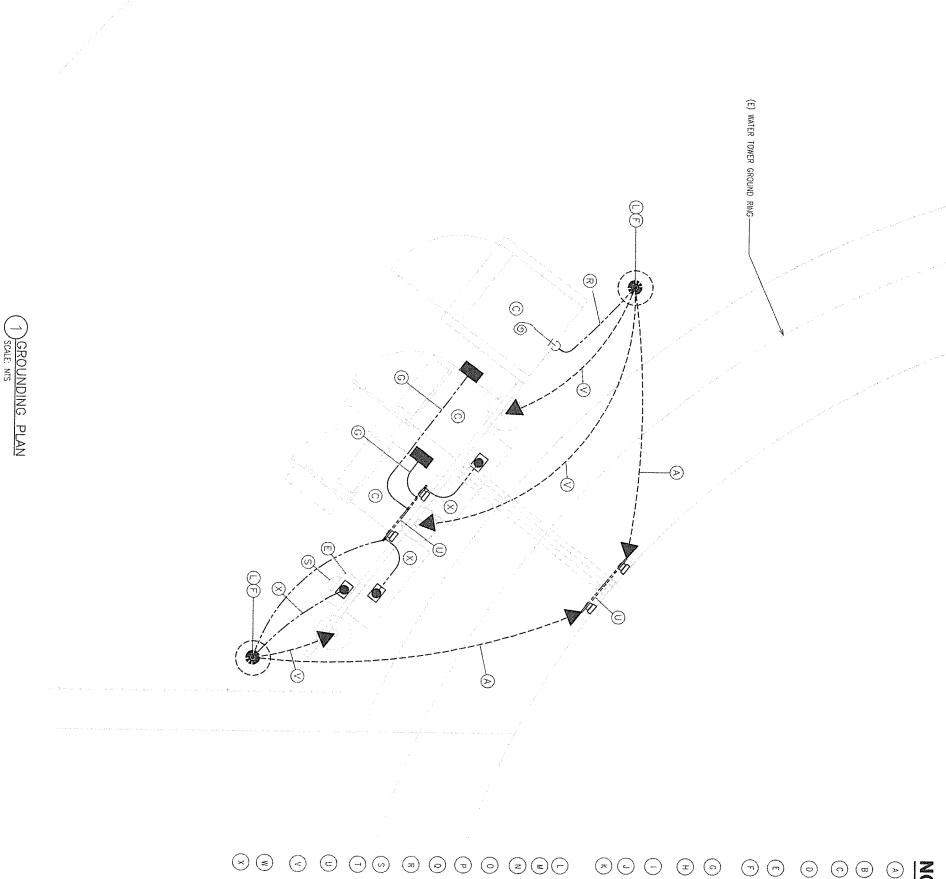

NOTES: REFERENCED ၂ GROUNDING PLAN

REVISIONS

ISSUED FOR CONSTRUCTION

08/03/17

DATE

- #2 awg solid thined copper ground wire 30" minimum below grade. Cadweld to each ground rod shown. Locate 24" minimum from New Building Foundation.
- #2 BARE SOLID TINNED COPPER GROUND WIRE 18* MINIMUM BELOW GRADE OR 6" BELOW FROST LINE, WHICHEVER IS GREATER. CADWELD TO GATE AND CORNER FENCE POSTS. PROVIDE FLEXIBLE BRADED JUMPER AT GATES.
- NEW ERICSSON EQUIPMENT CABINETS.

NOT USED

- NEW SERVICE ENTRANCE DISCONNECT SWITCH.
- 5/8" DIAMETER X 10' COPPER CLAD GROUND ROD. DRIVE LOCATED AT GROUND RING EVENLY SPACE GROUND RODS THE GROUND ROD LENGTH BUT NO MORE THAN 1 1/2" T TO 18" BELOW SURFACE. REFER TO 3/E94, WHERE SIMILAR TO THAT SHOWN BELOW BUT TYPICALLY TWICE HAT LENGTH.
- #2 AWG SOUD TINNED COPPER GROUND WIRE, CONNECT TO FOUNDATION. EXOTHERMICALLY WELD, TEST FOR RESISTANCE. GROUND RING AND STEEL REBAR IN CONCRETE VERIFY WELD NON-POROUS OR RE-WELD.

CELERIS PROJECT NO.: 16-8534

- #2 AWG SOLID TINNED COPPER GROUND WIRE 18" BELOW POSTS.

GRADE FOR CONNECTION

TO ICE BRIDGE SUPPORT

- NOT USED NOT USED
- REFER TO GROUND ROD WITH ACCESS AREA DETAIL 2/E04.
- PROVIDE "INTERSECT" PANEL, 200A, 103W, 240V COMBINATION MANUAL TRANSFER SWITCH, SURGE PROTECTOR, PANELBOARD "A" AND. REFER TO PANEL SCHEDULE FOR CIRCUIT BREAKERS.
- INTERLOCKED 240V, 2004 GENERATOR RECEPTACLE
- \$2 bare sound tinned copper ground wire in 3/4" PVC conduit from intersect panel down to ground ring and cadweld.
- VERIFY ACTUAL MOUNTING LOCATION WITH AT&T WIRELESS CONSTRUCTION,
- #2 TINNED COPPER GROUND WIRE 18" BELOW GRADE. PROVIDE SIGNIFICANT LEAD WIRE FOR CABINET CONNECTION
- NEW METER BASE AND JAWS BY E.C. AS APPROVED BY LOCAL ELECTRIC SERVICE PROVIDER
- PROVIDE #6 AWG BARE SOLID TINNED COPPER GROUND WIRE FROM GROUND RING TO TELEPHONE CABINET GROUND BAR. PROVIDE 3/4" PVC SLEEVE WHERE ABOVE GRADE.
- NEW 30" \times 4" \times 1/4" PRE-DRILLED COPPER ANTENNA GROUND BAR. PROVIDE STAND OFF ISOLATORS. VERIFY EXACT LOCATION WITH AT&T WIRELESS.
- #2 Bare solid thined copper ground wire from utility down to ground ring. Provide cadweld connections.
- #2 BARE SOLID, TINNED COPPER GROUND WIRE EXOTHERMICALLY CADWELDED TO TOWER GROUND RING.
- 1½2 AWG GEC (GROUNDING ELECTRODE CONDUCTOR) DOWN WITH MECHANICAL COUPLING IN GROUND INSPECTION PORT HAVING JURISDICTION. IN 3/4" CONDUIT TO 10' GROUND ROD. CONNECT OR AS DIRECTED BY CODE ENFORCEMENT AUTHORITY



8/3/17

E03

D8/03/17

PLOT SCALE
1:2
1:2
DEMPING NAME
ELECTRICAL GROUNDING
PLAN JNIVERSITY PARK WATER TOWER SITE NAME DRAWN BY:
KDR
CHECKED BY:
RT





at&t

Torres Engineering
Services, Inc.
8237 Delafield Dr.
Ft. Worth, Texas 76131
(682) 556-0848
Registration No. F-10147

2000 E. Lamar Blvd., Sulte 550 Arlington, TX 76006 Office: 817.446.1700 Fax: 817.460.0677

1801 VALLEY VIEW LANE FARMERS BRANCH, TX 75234

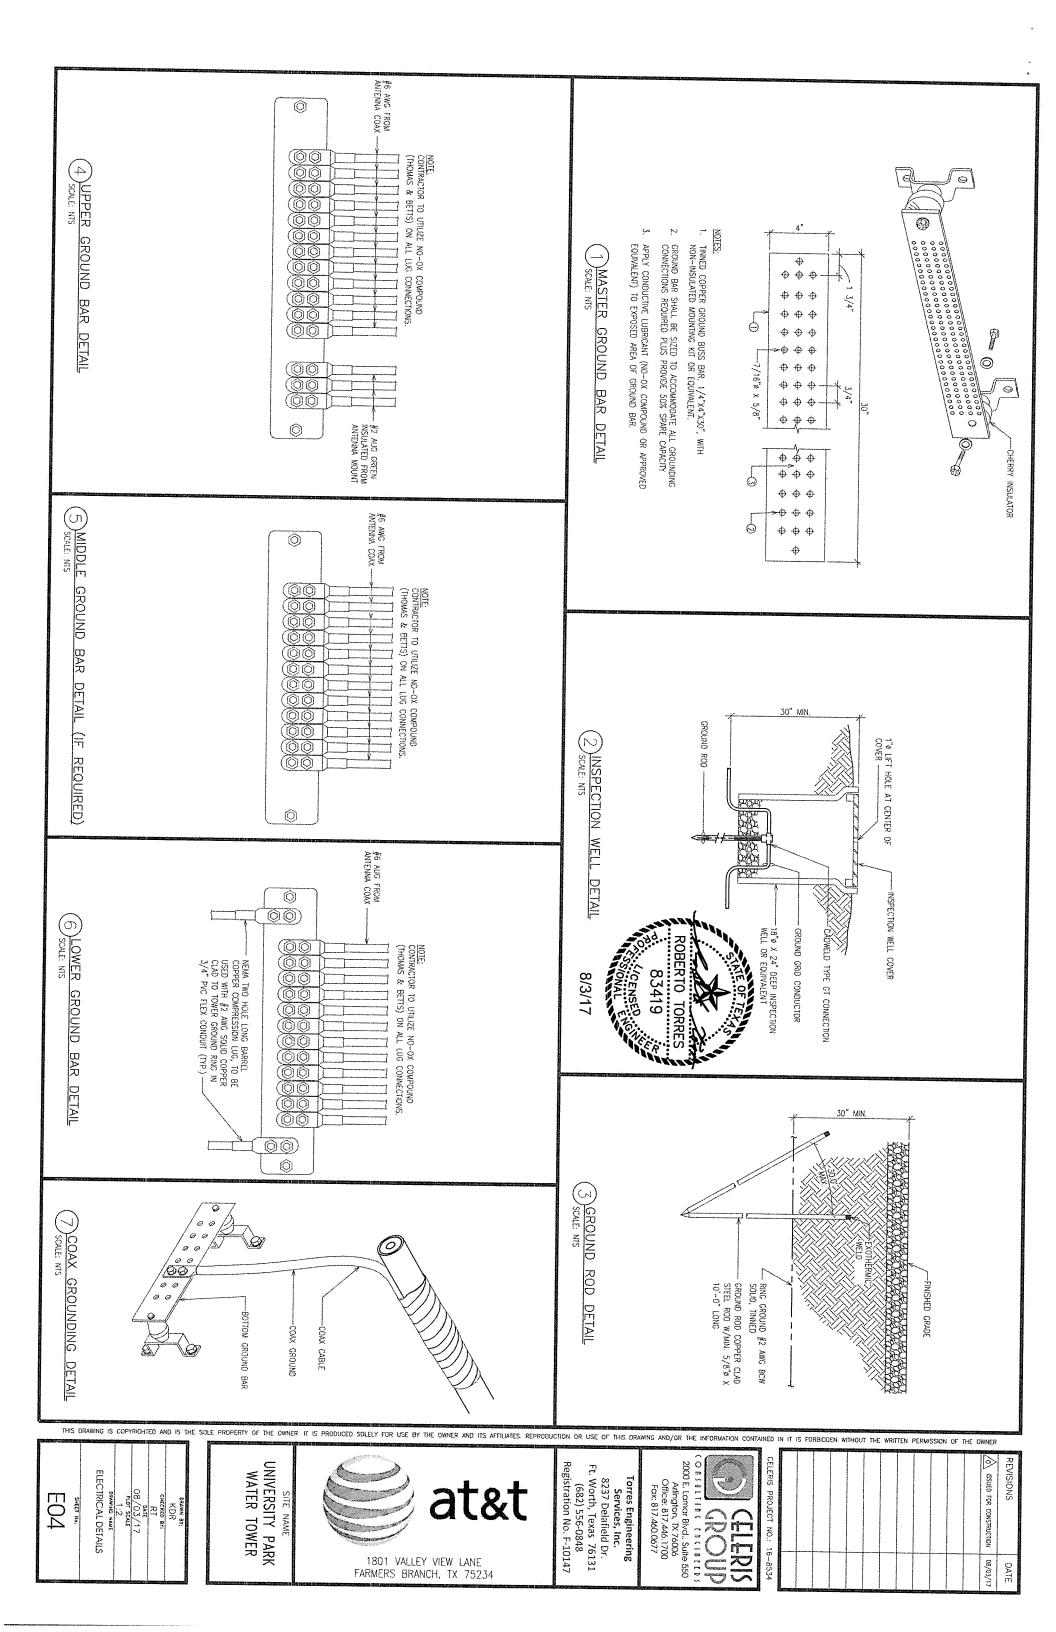

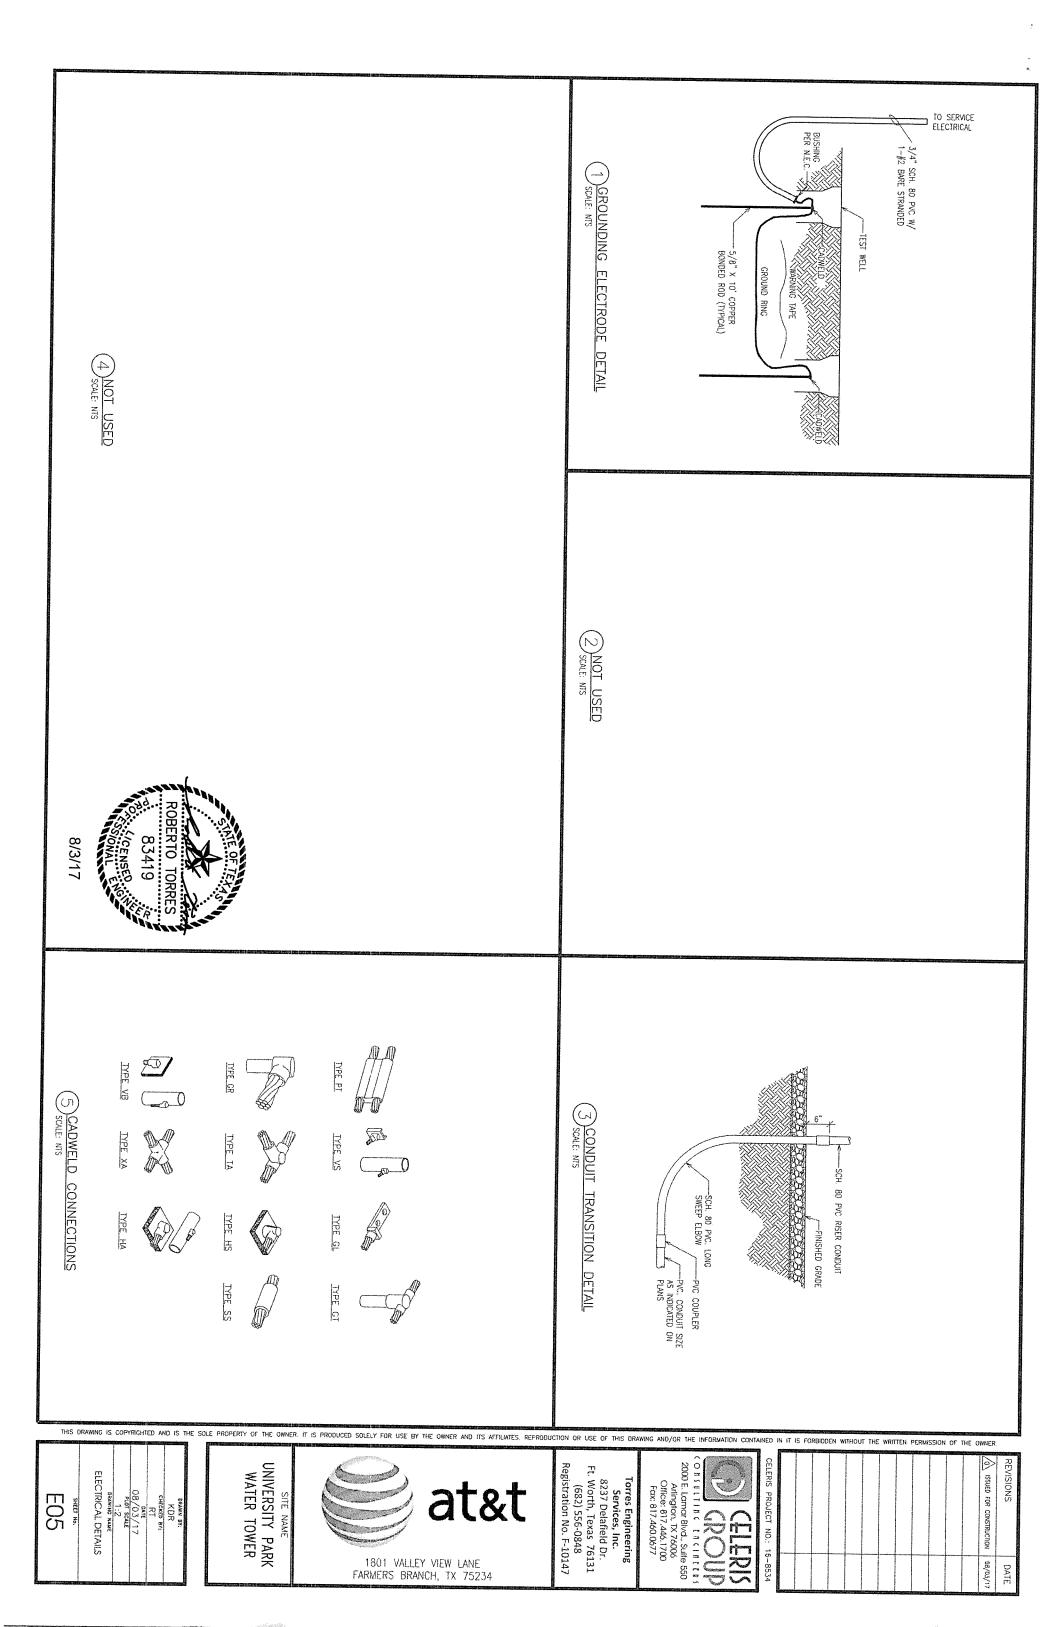

THE REQUIREMENTS PRESENTED IN THESE SPECIFICATIONS PERTAINS TO ELECTRICAL INSTALLATION OF A COMPLETELY NEW POWER RACEWAY SYSTEM FOR THE ATA'T WIRELESS INSTALLATION TO THE EXTENT REQUIRED BY THESE CONTRACT DOCUMENT.

IN GENERAL, THE ELECTRICAL CONTRACTOR (HEREAFTER ALTERNATELY REFERRED TO AS 'CONTRACTOR') SHALL PROVIDE OR RESTORE THE FOLLOWING EXISTING SYSTEMS:
A. CONDUIT AND RACEWAYS FOR ALL DEVICES, COUPMENT, GROUND BUSSES AND GROUND ROOS INDICATED ON THE ELECTRICAL PLANS.
B. CONTRACTOR SHALL RUN REDEERS SHOWN TO SUPPLY POWER TO ALL EQUIPMENT INDICATED PRIOR TO BID. CONTRACTOR
SHALL DETERMINE ANY ADDITIONAL POWER OR GROUNDING WHICH MAY BE REQUIRED DEPENDING ON EQUIPMENT SPECIFIC TO

CONTRACTOR(S) WISHING TO BID THIS WORK SHALL BE ABLE TO DEMONSTRATE A MINIMUM OF 5 YEARS PREVIOUS EXPERIENCE WITH THIS TYPE OF PROJECT AND SHALL, <u>IF, REQUESTED</u>, SUPPLY DOCUMENTATION TO SUPPORT THIS REQUIREMENT OF QUALIFICATION.

3. EACH QUALIFED BIDDER SHALL OBTAIN ALL PROPER BID FORMS AND SHALL VISIT THE SITE TO DETERMINE ACTUAL EXISTING CONDITIONS PRIOR TO PREPARING A BID.

4. CONTRACTOR SHALL NOTE THAT IF THIS CURRENTLY HOSTS ONE OR MORE OTHER TENANTS WITH TELEPHONE AND/OR ELECTRICAL SERVICE, CONTRACTOR SHALL NOT CAUSE LOSS OF POWER, COMMUNICATION OR ANY REQUIRED SERVICES TO AT&T WRELESS OR ANY OTHER SITE OCCUPANT IN ANY MANNER WITHOUT EXPRESS WRITTEN DRECTION BY AT&T WRELESS CONSTRUCTION SUPERVISION. THE CONTRACTOR SHALL BE LIABLE FOR ANY LOSS OF REVENUE TO ANY SITE OCCUPANT BECAUSE OF ANY NONSCHEDULED OUTAGES AS DETERMINED BY CONTRACT AGREEMENT WITH AT&T WIRELESS.

GENERAL: IT IS THE INTENTION OF THESE SPECIFICATIONS AND THE RELATED PLANS TO SHOW COMPLETE, PROPERLY FUNCTIONING SYSTEMS ALL SYSTEMS, WIRING AND RACEWAYS SHALL BE INSTALLED PER NFPA-70 (APPLICABLE) AND AUTHORITY HAVING JURISDICTION

- 102 SPECIAL CONDITIONS FOR ELECTRICAL WORK:

 THE CONSTRUCTION DOCUMENTS INCLUDING BUT NOT LIMITED TO THESE PLANS, SPECIFICATIONS, AND CONTRACTS ARE ISSUED FOR INFORMATION TO BE COMPUED WITH BY THE
 ELECTRICAL CONTRACTOR AND ANY OR ALL SUBCONTRACTORS AND TRADES EMPLOYED ON THIS PROJECT BY THE ELECTRICAL CONTRACTOR, HEREAFTER REFERRED TO AS CONTRACTOR.
- THE TERM "CONTRACTOR" IN THIS SECTION REFERS TO THE CONTRACTOR WHOSE WORK IS COVERED BY THIS ELECTRICAL SPECIFICATION.
- ALL WORK SHALL BE DONE AND TESTED IN ACCORDANCE WITH THESE PLANS AND SPECIFICATIONS AND WITH LOCAL AND MATIONAL CODES, REPORT SUPPOSED CONFLICTS WITH PLANS AND SPECIFICATIONS IMMEDIATELY TO THE CONSTRUCTION SUPERINTENDENT WHO WILL ISSUE INSTRUCTIONS OR ADDENNA TO RESOLVE SUCH CONFLICT IN NO CASE SHALL A CONTRACTOR BASE ITS BIS ON WORK THAT WILL NOT BE ACCEPTABLE TO CODE AND THESE CONTRACT DOCUMENTS. NO CONSIDERATION SHALL BE OWEN TO REQUESTS FOR EXTRA COMPENSATION TO BRING THE BASE WORK INTO CONFORMANCE WITH THESE DOCUMENTS.
- ALL MATERIAL FOR WHICH THERE IS A CATEGORY FOR TESTING BY UL OR CSA SHALL BE SO TESTED, LISTED AND LABELED.
- AS MENTIONED ABOVE, IT IS THE INTENT OF THESE DOCUMENTS TO PRODUCE A COMPLETE AND FINISHED ELECTRICAL SYSTEM TO THE EXTENT SHOWN IN THESE CONTRACT DOCUMENTS. THE LATET WIRELESS CONSTRUCTION MANAGER SHALL BE THE FINAL AUTHORITY FOR ACCEPTANCE OF THE WORK. THE CONTRACTOR IS SOLELY RESPONSIBLE FOR COORDINATING HIS WORK WITH OTHER TRADES AND WITH HIS SUBCONTRACTORS AS NECESSARY TO PROVIDE A FINAL AND COMPLETE ELECTRICAL INSTALLATION.
- THE CONTRACTOR SHALL EMPLOY ONLY SKILLED, EXPERENCED, AND WHEN REQUIRED, LICENSED SUB CONTRACTORS AND WORKERS. MATERIALS AND EQUIPMENT SHALL BE INSTALLED IN ACCORDANCE WITH THE BEST TRADE PRACTICES AND IN A NEXT AND WORKAN LIKE MANNER WORK WHICH IN THE OPINION OF THE CONSTRUCTION MANNEER DOES NOT CONFORM TO THE INTENT OF THESE PLANS AND SPECIFICATIONS SHALL BE REMOVED AND REPLACED AT THE CONTRACTOR'S EXPENSE.
- THE PLANS AND DETAILS ARE DINGRAMMATIC IN NATURE COORDINATE THE LOCATION OF ITEMS NOT CLEARLY DIMENSIONED WITH THE CONSTRUCTION SUPERINTENDENT
- SECURE ALL NECESSARY PERMITS, LICENSES AND INSPECTIONS AND PAY ALL REQUIRED FEES, TESTS AND WAGE SCALES THAT MAY BE REQUIRED. THE CONTRACTOR SHALL INCLUDE THE FINAL INSPECTION CERTIFICATE IN FINAL DOCUMENTS.
- THE CONTRACTOR IS RESPONSIBLE FOR UNDERSTANDING THE EXISTING SITE CONDITIONS, HE SHALL VISIT THIS SITE (BY APPOINTMENT) AT ANY REASONABLE TIME
- ō . LOCATONS OF UTILITY CONNECTIONS SHOWN ON THE SITE ARE APPROXIMATE AND ARE BASED ON SITE OBSERVATIONS ACTUAL UTILITY CONNECTIONS AND EXACT LOCATIONS MAY VARY SLIGHTLY. THE CONTRACTOR SHALL CONNECTION. THE CUNTRACTOR SHALL NAVIVARY SLIGHTLY. THE CONTRACTOR SHALL CONDITIONS OF CONNECTION AND ANY FEES REQUIRED BY THE UTILITY FOR PROPOSED NEW 200 AMP, 240/120 VAC SINGLE PHASE UTILITY SERVICE THE CONTRACTOR SHALL CONDRINATE WITH THE ELECTRICAL COMPANY CONCERNING HEAS WHICH THE MIST PROVIDE AND THE CONSTRUCTION SCHEDULE.
- AFTER COMPLETION OF THE WORK AND BEFORE FINAL INSPECTION, THE CONTRACTOR SHALL THOROUGHLY CLEAN EACH EXPOSED DEVICE, PIECE OF EQUIPMENT AND FIXTURE TO THE SATISFACTION OF THE CONSTRUCTION SUPERINIENDENT.
- THE CONTRACTOR SHALL SUBMIT ALL MATERIALS LISTED BELOW TO THE ENGINEER FOR APPROVAL PRIOR TO INSTALLATION. FAILURE TO OBTAIN APPROVAL ON MATERIAL SHALL BE CAUSE FOR CONTRACTOR TO REMOVE ANY MATERIALS NOT APPROVED AND REPLACE THEM AT HIS OWN EXPENSE AND WITH NO ALLOWANCE IN THE TIME ALLOWED FOR CONSTRUCTION MANAGER).

 SUBMITIALS. (PROVIDE IN QUANTITY REQUESTED BY THE CONSTRUCTION MANAGER)

THE FOLLOWING MINIMUM ITEMS SHALL BE SUBMITTED AT THE SAME TIME UNDER ONE COVER IN THE ORDER LISTED.

SWITCHES, ENCLOSURES, CABINETS, TIMERS, AND RECEPTACLES WIRE, CONDUIT, GROUND RODS, GROUND BUSSES, ELECTRICAL (CAD) WELD DEVICES. METALLIC SHEATHED FLEXIBLE CONDUIT, OUTLET AND PULL BOXES.

TAB TWO: TAB THREE: PANEL BOARDS, DISCONNECT SWITCHES (DESIGNATE USE OF EACH), FUSES, AND CIRCUIT BREAKERS OR OTHER CONTROL DEVICES.

THE CONTRACTOR SHALL GUARANTEE THAT ALL WORK PERFORMED UNDER THIS CONTRACT IS FREE FROM DEFECTS IN MATERIAL AND WORKMANSHIP FOR ONE YEAR (MINIMUM) FOLLOWING FINAL ACCEPTANCE BY THE OWNER'S REPRESENTATIVE. THE CONTRACTOR SHALL RESPOND TO REQUESTS FOR SERVICE IN A TIMELY MANNER APPROPRIATE TO THE SERVICE REQUESTED, THE CONTRACTOR SHALL IMMEDIATELY REPAIR OR REPLACE ANY TIEMS FOUND TO BE DEFECTIVE WITHIN THE GUARANTEE PERIOD AT NO COST TO THE OWNER.

. THE CONTRACTOR SHALL MANIAM ON THE SITE A SET OF CONSTRUCTION DOCUMENTS MARKED IN RED TO SHOW THE ACTUAL CONDITIONS OF CONSTRUCTION. LOCATIONS OF EQUIPMENT AND ROUTING OF SYSTEMS SHALL BE ACCURATELY RECORDED DURING THE COURSE OF CONSTRUCTION. CONTRACTOR SHALL FORWARD A REPRODUCIBLE COPY OF THE RECORD DRAWINGS TO ATA! WRELESS AT THE COMPLETION OF CONSTRUCTION AND SHALL MANIAM THE ORROWN RECORD DRAWINGS FOR USE DURING THE GUARANTEE PERIOD.

FINAL PAY REQUEST SHALL NOT BE APPROVED WITHOUT THIS FINALIZED INFORMATION IN ACCORDANCE WITH ATAS! WIRELESS CLOSE OUT INSTRUCTIONS.

15. IN ADDITION TO THE ABOVE REQUIRED RECORD DRAWINGS, THE CONTRACTOR SHALL FURNISH TO ATAIT WIRCLESS AT THE COMPLETION OF THE WORK THE FOLLOWING DOCUMENTS: TEST REPORTS, WARRANTIES, OPERATIONS AND MAINTENANCE MANUALS AND INFORMATION:

- A. A CERTIFICATE OF GUARANTEE/WARRANTY SHOWING THE DATES OF BEGINNING AND ENDING OF THE WARRANTY B. DOCUMENTS PERTINDIAT TO THE GUARANTEES AND WARRANTES OF MANIFACTURERS.

 C. WRITTEN INSTALLATION INSTALLATIONAL STREAM COLUMENT INSTALLED ON THE PROJECT.

 D. THREE SETS OF CUT SHEETS FOR EACH PIECE OF EQUIPMENT INSTALLED FOR ELECTRICAL SYSTEMS.

 E. CERTIFIED RESISTANCE MEASUREMENT DATA AND DRAWINGS USED DURING CONSTRUCTION.
- 16. ALL MATERIALS SHALL BE NEW AND OF DOMESTIC, OR IF APPROVED, NAFTA MANUFACTURE. ALL ITEMS OF THE SAME TYPE ON THE PROJECT SHALL BE OF THE SAME MANUFACTURER.
- PRODUCTS OF VARIOUS MATERIALS AND EQUIPMENT ARE SPECIFIED IN ORDER TO ESTABLISH A STANDARD OF QUALITY AND A BASIS OF DESIGN. OTHER SIMILAR MATERIALS MAY BE ACCEPTABLE AS SUBSTITUTIONS PROVIDED THEY MEET THE SAME STANDARDS OF QUALITY AND DESIGN CRITERIA IN THE OPINION OF THE ENGINEER ALTERNATE ITEMS SHALL BE SUBMITED TO THE DICKNOWN ACCEPTABLITY SHALL BE FINAL. THE CONTRACTOR SHALL BEAR ALL COSTS, INCLUDING THAT OF OTHER TRADES AND THE DESIGN TEAM, ASSOCIATED WITH ACCOMMODATIONS FOR PERMITTED SUBSTITUTIONS

- 1.612.3 WIRE AND CABLE 1. ALL WIRE AND CABLE SHALL BE COPPER OF AT LEAST 98% CONDUCTIVITY.
- 2. ALL INSULATION SHALL BE TYPE THAN EXCEPT TYPE THW MAY BE USED FOR SIZES LARGER THAN #6 AND
- 4. A STRUCT METHOD OF COLOR CODING SHALL BE MAINTAINED UNLESS THE AUTHORITY HAVING JURISDICTION HAS A DIFFERENT STANDARD, THE FOLLDWING SHALL A PHASE BLACK, B PHASE: RED, (AND WHERE USED.) C PHASE: BLUE; NEUTRAL: WHITE; GROUND: GREEN; SWITCH LEG. BROWN. TRAVELERS: BROWN. 3. NO WIRE SMALLER THAN #12 AWG MAY BE USED EXCEPT THAT CONTROL CIRCUIT MAY BE #14.

SIZES LARGER THAN BE MAINTAINED:

REVISIONS

ISSUED FOR CONSTRUCTION

08/03/17

6. UL LISTED WIRE PULLING LUBRICANT SHALL BE USED ON ALL RACEWAY INSTALLATIONS. WRE CONNECTORS FOR #8 AND SMALLER MAY BE SPRING STEEL CONNECTORS. SPLIT BOLT CONNECTORS WITH RUBBER AND VIVIL TAPE SHALL BE USED FOR #8 POWER DISTRIBUTION BLOCKS MAY BE USED FOR ANY SIZE CONDUCTOR FOR WHICH IT IS LISTED.

- ALL WIRING ABOVE GRADE OR OTHERWISE EXPOSED SHALL BE IN METALLIC CONDUIT. TYPE MC CABLE OR FLEXIBLE CONDUIT MAY NOT BE USED UNLESS SHO EMT. GALVANNZED INTERMEDIATE AND RIGID CONDUIT ARE ALL ACCEPTABLE WIRING MATERIALS FOR ABOVE GRADE PROVIDED THEY ARE ACCEPTABLE TO LOCAL C OWN OR REQUIRED BY THESE SPECIFICATIONS CODE ENFORCEMENT.
- 2. ALL FITTINGS SHALL BE <u>COMPRESSION TYPE OR SCREW TYPE</u> AND MAY NOT BE DIE CAST SET SCREW.
- 3. CONDUIT BELOW GRADE SHALL BE SCHEDULE 40 PVC WITH WATCHING FITTINGS EXCEPT THAT ELBOWS AND VERTICAL CONDUITS IN CONTACT WITH EARTH WHICH ARE LIKELY TO BE DAMAGED BY EXCESSIVE PULLING ROPE TENSION MAY BE PLASTIC WEAPPED INTERMEDIATE OR RIGID GALVANIZED STEEL.
- 4. EXPOSED CONDUIT OUTDOORS ABOVE GRADE OR IN DAMP LOCATIONS SHALL BE CALVANIZED RIGID STEEL OR INTERNEDIATE METALLIC CONDUIT.
- 92 VIBRATING EQUIPMENT.
- ULTRAVIOLET PROTECTED PLASTIC COATED FLEXBLE METAL CONDUIT MAY BE USED WHERE INDICATED AND GITHERWISE FOR THE CONNECTION OF ROTATING (SUCH EQUIPMENT LOCATED OUTDOORS OR IN DAMP LOCATIONS SHALL BE CONNECTED WITH LIQUID TIGHT FLEXBLE METAL CONDUIT USING LISTED FITTINGS, MINIMUM COVER FOR OUTDOOR CONDUITS SHALL BE 36 INCHES. NOTE: UTILITY COMDUITS MAY HAVE A GREATER DEPTH REQUIREMENT,

16250 GROUNDING 1. ALL EQUIPMENT AND SERVICE ENTRANCE GROUNDING SHALL BE PER NFPA-70 CURRENT EDITION AS ADOPTED BY LOCAL AUTHORITY HAVING JURISDIC PALL EQUIPMENT AND SERVICE ENTRANCE GROUNDING SHALL BE PER NFPA-70 CURRENT EDITION AS ADOPTED BY LOCAL AUTHORITY HAVING JURISDIC ATAT WIRELESS STANDARDS ON EQUIPMENT GROUNDING. OTION ON THIS PROJECT.
N) AND

- 18400 WIRING DEVICES 1. ALL WIRING DEVICES SHALL BE SPECIFICATION GRADE RATED AT 20 AMPS.
- PROVIDE DEVCES AS SHOWN ON DOCUMENTS. CONSULT WITH CONSTRUCTION MANAGER AND DIHER TRADES FOR EXACT LOCATION OF OUTLETS. EQUIPMENT AND WHERE POSSIBLE, CONCEAL OUTLET BEHIND THAT EQUIPMENT. WHERE SERVE A SPECIFIC PIECE

2000 E. Lamar Blvd., Suite 550 Arlington, TX 76006 Office: 817.446.1700 Fax: 817.460.0677

NO.: 16-8534

(682) 556-0848 egistration No. F-10147 Ft. Worth, Texas 76131

8237 Delafield Dr. Forres Engineering Services, Inc.


1. VERIFY THAT THE INTERRUPTING RATING OF CIRCUIT BREAKERS SHALL BE GREATER THAN THE AVAILABLE FAULT CURRENT. VERIFY THE AVAILABLE FAULT CURRENT WITH THE SERVING ELECTRICAL PANEL BOARDS: VERIEY PROVIDED BY AT&T WIRELESS (OR CONTRACTOR) AND INSTALLED BY THIS CONTRACTOR,

- 2. PROVIDE SOLID NEUTRALS ON ALL PANELS AND. MAIN SERVICE ENTRANCE DISCONNECT (IF MAIN SERVICE DISCONNECT REQUIRED),
- PROVIDE 1" BLACK MICHETA TAGS WITH 1/2" WHITE LETTERS FOR EACH PANELBOARD AND DISCONNECT MATCHING PROJECT DOCUMENTATION TAGS SHALL BE "POP-RIVETTED" THROUGH PANEL COVER.

- 600 LIGHTING FIXTURES (IF SHOWN) PROVIDE LIGHTING FIXTURES AS SHOWN ON THE DOCUMENTS. QUESTIONS ON LIGHT FIXTURE TYPES SHALL BE DIRECTED TO AT&T WIRELESS FOR CLARIFICATION. THE CONTRACTOR SHALL PROVIDE ALL LIGHTING FIXTURES.
- 2. FASTEN EACH LIGHTING FIXTURE TO AN QUILET BOX OR STRUCTURAL FRAMING. INCLUDE ALL NECESSARY HARDWARE AND SUPPORTING DEVICES TO ACCOMPUSH THIS.
- 3. PROVIDE NEW LAMPS OF THE TYPE RECOMMENDED BY THE PLANS AND SPECIFICATION AT THE TIME OF FINAL ACCEPTANCE.

 4. ALL LIGHTING FIXTURES SHALL BE CLEAN AND FULLY OPERATIONAL AT THE TIME OF FINAL ACCEPTANCE. ALL LIGHTING FIXTURES SHALL BE CLEAN AND FULLY OPERATIONAL AT THE TIME OF FINAL ACCEPTANCE.
- 16700 EQUIPMENT CONNECTIONS

 1. PROVIDE ELECTRICAL POWER AND LIGHTING CONNECTIONS FOR ALL EQUIPMENT ON THE PROJECT WHETHER FURNISHED BY THIS CONTRACTOR OR OTHERS.
- CAREFULLY RESEARCH THE DOCUMENTS AND CONSULT WITH OTHERS TO DETERMINE THE REQUIREMENTS FOR CONNECTIONS
- SPECIAL MODULAR CELL INSTALLATION GROUNDING INTEGRITY AND IMPEDANCE TESTING:
- COMPACTOR SHALL PRESENT MEASUREMENTS SHOWING CERTIFIED THIRD PARTY GROUND IMPEDANCE TESTING AS REQUIRED BY THE TESTING PER ANS/TEEE STD 81-1983, HEEE GUIDE FOR MEASURING EARTH RESISTINITY SHALL BE AS APPROVED BY ATAT WIRELESS S CONTRACT DOCU
- THIS INSTALLATION SHALL BE GROUNDED WITH AN INTEGRATED (MULTI-POINT) GROUNDING SYSTEM
- SURGE PROTECTION SHALL BE ATAT WIRELESS APPROVED EQUIPMENT. IT SHALL BE BONDED TO A CROWND BAR AT THE SERVICE ENTRANCE POINT THAT IS CONNECTED DIRECTLY TO THE GROUNDING ELECTRODE SYSTEM.
- REVIEW EXISTING INSTALLATION AND FOLLOW ATAT WIRELESS CEIL SITE GROUNDING AND LIGHTNING PROJECTION STANDARDS REPORT PERCENCED DIFFICULTIES WITH MEETING THIS CRITERIA WITH ATAT WIRELESS CONSTRUCTION MANAGEMENT. OTHER REQUIRED STANDARDS SHALL BE: NFPA-780 STANDARD FOR INSTALLATION OF LIGHTNING SYSTEMS AND POLY PHASE EQUIPMENT; AND, THE GROUNDS FOR LIGHTNING PROTECTION AND EMP PROTECTION*, SECOND ED. BY ROGER R. BLOCK.
- THE ELECTRICAL CONTRACTOR SHALL PROVIDE BONDING STRAPS, CAD WELDING AND HARDWARE FOR EACH SEPARATE PIECE OF MOUNTING PLATFORM TO ASSURE THAT ALL PIECES, ARE ELECTRICALLY CONNECTED. SUCH CONNECTIONS SHALL BE MADE AND 1 TO DEMONSTRATE LOW ELECTRICAL RESISTANCE ACCEPTABLE TO ATAZI WIRELESS BETWEEN ANY TWO POINTS ON THE PLATFORM, OR STRUCTURE. EQUIPMENT

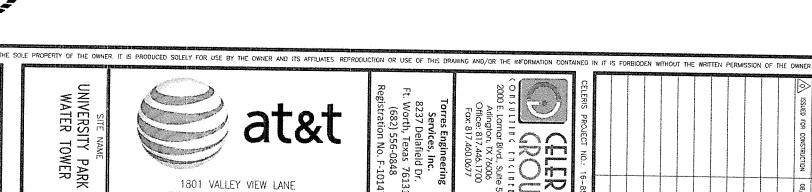

FARMERS BRANCH, TX 75234

NIVERSITY PARK WATER TOWER

SI	NSE OF THE PROPERTY OF THE PRO	is co	O O	RIGHT	TODDE A	ND I	\ \ \ \ \ \ \ \ \ \ \ \ \ \ \ \ \ \ \
SHEET No.	ELECTRICAL SPECIFICATIONS	1:2	PLOT SCALE	08/03/17	RT RT	KDR	DRAWN BY:

8/3/17