

ORDINANCE NO. _____

AN ORDINANCE OF THE CITY OF UNIVERSITY PARK, TEXAS, AMENDING THE COMPREHENSIVE ZONING ORDINANCE OF THE CITY OF UNIVERSITY PARK, BY APPROVING AN AMENDED DETAILED SITE PLAN FOR PLANNED DEVELOPMENT DISTRICT 15 “PD-15” FOR UNIVERSITY PARK ELEMENTARY SCHOOL, THE PROPERTY BEING DESCRIBED AS LOTS 1-26, BLOCK C, OF THE UNIVERSITY HEIGHTS ADDITION REVISED, AN ADDITION TO THE CITY OF UNIVERSITY PARK, DALLAS COUNTY, TEXAS, RECORDED IN VOLUME 3, PAGE 383, OF THE MAP RECORDS OF DALLAS COUNTY, TEXAS AND MORE COMMONLY KNOWN AS 3505 AMHERST; PROVIDING SPECIAL CONDITIONS; PROVIDING FOR THE REPEAL OF ALL ORDINANCES IN CONFLICT; PROVIDING A SEVERABILITY CLAUSE; PROVIDING FOR A PENALTY OF FINE NOT TO EXCEED THE SUM OF TWO THOUSAND DOLLARS (\$2,000.00) FOR EACH OFFENSE; AND PROVIDING AN EFFECTIVE DATE.

WHEREAS, the Planning and Zoning Commission of the City of University Park and the City Council of the City of University Park, in compliance with the laws of the State of Texas with reference to the granting of zoning classifications and changes, have given the requisite notices by publication and otherwise, and have held due hearings and afforded a full and fair hearing to all property owners generally and to all persons interested and situated in the affected area and in the vicinity thereof, and the City Council of the City of University Park is of the opinion and finds that amendment of the Detailed Site Plan for PD-15 should be approved and that the Comprehensive Zoning Ordinance and Map should be amended accordingly; Now, Therefore,

BE IT ORDAINED BY THE CITY COUNCIL OF THE CITY OF UNIVERSITY PARK, TEXAS:

SECTION 1. That the Comprehensive Zoning Ordinance and Map of the City of University Park, Texas, as heretofore amended, is amended by approval of an amended detailed site plan for Planned Development District 15, the property being described as Lots 1-26, Block C, of the University Heights Addition Revised, an Addition to the City of University Park, Dallas County, Texas, recorded in Volume 3, Page 383, of the Map Records of Dallas County, Texas and more commonly known as 3505 Amherst.

SECTION 2. That the amended detailed site plan setting forth the authorized land uses for the property is attached hereto as Exhibit “A” and made a part hereof for all purposes, the same as if

fully copied herein (“site plan”). That such site plan contains the data required by Section 17-101 (2) of the Comprehensive Zoning Ordinance.

SECTION 3. That the approval of this site plan for Planned Development District No. 15 is subject to the following special conditions:

A. Development of the property shall be in accordance with the approved site plan and all provisions of PD 15 and the Comprehensive Zoning Ordinance of the City of University Park, as heretofore amended and as amended hereby.

B. Construction of a new school building on the site is approved, including an underground parking garage with 85 spaces, as shown on the site plan.

C. The following setbacks shall apply to the building:

1. North (rear) setback shall be 20.3’;
2. South (front) setback shall be 39.4’;
3. East (side) setback shall be 54.4’;
4. West (side) setback shall be 239.2’.

D. The maximum height measured from the parapet shall be:

1. The Classroom portion of the building (Area A) shall be 48’;
2. The Administration portion of the building (Area B) shall be 40’;
3. The Activity portion of the building (Area C) shall be 34’.

E. A construction fence around the site will be required during construction, beginning with demolition of existing improvements; no explosives may be used in demolition of the existing building.

F. A full-time point of contact will be provided by the HPISD to answer questions and complaints during construction.

- G. All construction vehicles shall be required to park on-site during construction.
- H. HPISD and its contractors shall observe construction hours of 7:00 a. m. to 6:00 p. m., Monday-Saturday, and as limited by the University Park Code of Ordinances.
- I. All workers on site during construction must submit to background checks as part of the contractors' responsibility.
- J. Debris, excavation spoils, and construction materials haul and delivery routes must be approved in writing by the Director of Public Works or his designee.

SECTION 4. That all ordinances of the City of University Park in conflict with the provisions of this ordinance or the Comprehensive Zoning Ordinance as amended hereby are hereby repealed.

SECTION 5. That should any sentence, paragraph, subdivision, clause, phrase or section of this ordinance be adjudged or held to be unconstitutional, illegal, or invalid, the same shall not affect the validity of this ordinance or any part or provision thereof other than the part decided to be invalid, illegal or unconstitutional, and the same shall not affect the validity of the Comprehensive Zoning Ordinance.

SECTION 6. That any person, firm or corporation violating any of the provisions or terms of this ordinance or of the Comprehensive Zoning Ordinance, as amended hereby, shall be subject to the same penalty as provided for in the Comprehensive Zoning Ordinance of the City of University Park, Texas, as heretofore amended, and upon conviction shall be punished by a fine not to exceed the sum of two thousand dollars (\$2,000.00) for each offense, and each and every day such a violation is continued shall be deemed to constitute a separate offense.

SECTION 7. That this ordinance shall take effect immediately from and after its passage and the publication of the caption, as the law and Charter in such cases provide.

DULY PASSED by the City Council of the City of University Park, Texas, on the _____ day of _____ 2017.

APPROVED:

OLIN B. LANE, MAYOR

ATTEST:

CHRISTINE GREEN, CITY SECRETARY

APPROVED AS TO FORM:


CITY ATTORNEY
(RLD; 2-28-17; 84180)

EXHIBIT “A”

PD REVISION SUBMITTAL 2016.11.17

University Park ES Rebuild

3505 Amherst Ave
Dallas TX 75225

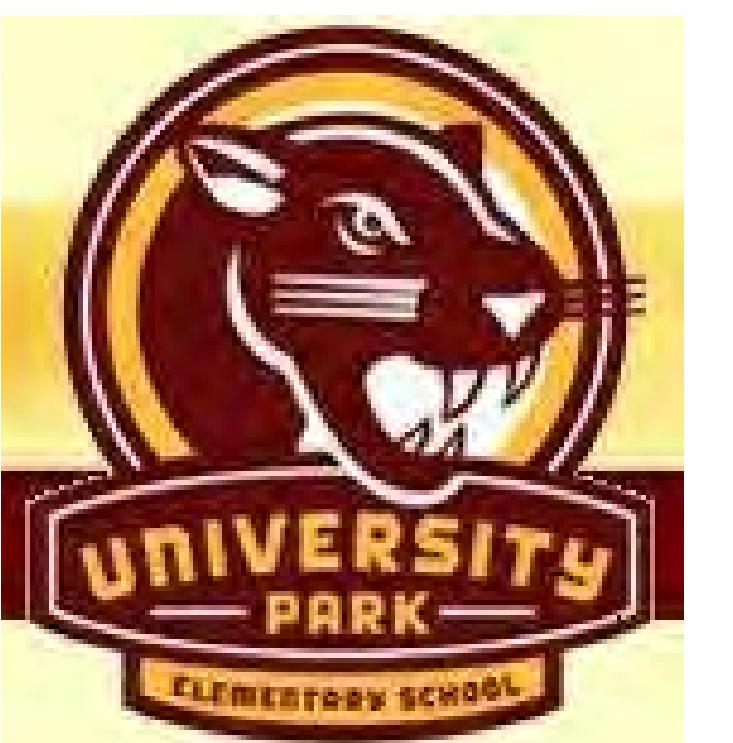

Stantec Project #: 214000361



DRAWING INDEX	
NO.	DRAWING NAME
CS1	OVERALL SITE PLAN
CS2	TRAFFIC PLAN
CU1	REMANUFACTURED UTILITY LAYOUT
CD1.0	EXISTING IMPERVIOUS CALCULATIONS WORKSHEET
L101	LANDSCAPE PLAN
P0111	GARAGE & FIRST FLOOR PLAN
P0121	SECOND LEVEL FLOOR PLAN
P0131	THIRD LEVEL FLOOR PLAN
P0200	RENDINGS
P0201	EXTERIOR ELEVATIONS
P0210	MASSING VIEWS SHOWING RTUS

UPES Land Use Statement:

It is the intent of the HPSD to demolish the existing University Park Elementary School and re-build a new school allowing for more efficient use of interior space and outdoor green space. The building is to be placed at approximately the same location on the site, but will be slightly more compact to provide an additional 20% of green space at the payoffs on the west side of the site and release green space to the north side of the site. As part of the construction process it is intended to move three trees from the east side of the building to the west side. The library, administrate, and fine arts portions of the building will be two story. The gymnasium and cafeteria will be 1.5 stories tall with an adjacent 1 story kitchen. Building heights are indicated on attached elevations. All trash services and building delivery services will remain in their approximate location on the site. New screening walls will be provided along the eastern side of the building in the service area. The existing electrical service running eastwest along Amherst from Dickens will be buried underground.

The exterior of the building is currently under design with community members and staff. The design of the building is to substantially match the existing building. The main exterior walls of the building will be 99% modular brick masonry with cast stone accents. A more decorative brick patterning is being proposed on some of the exterior elevations. Several elements from the existing building, such as some of the decorative cast stone entries, will be salvaged and re-used as part of the new facade and entry. Every effort is being taken to save as many trees on site as possible. As one example, a tree will be moved to the south end of the building during the demolition process. The design of the new main entry steps providing an elevated planter box to save the tree. Perspective drawings have been provided to show sight lines from the adjacent Right-of-Ways. It is the intent to screen mechanical units only when visible from these public Right-of-Ways. As an example, view C1 on sheet P0210 shows several blue boxes (representing mechanical units) that will require screening either by perforated or louvered screen walls.

A new underground parking garage will be constructed below the cafeteria and gym. The garage will provide from 63 spaces. The garage will be located directly beneath the cafeteria and gym. The garage will be designed as a westbound-in and westbound-out to prevent cross traffic entering the garage. The existing parking spaces on the north side of Lovers will remain except for the spots removed to accommodate the new parking garage entry.

Student pick-up and drop-off traffic will remain substantially similar in the new design as it currently functions today, with traffic queuing along Amherst Avenue and the primary student entry for morning arrival and afternoon dismissal being located on the north side of the new building.

Copyright Reserved

The Contractor shall verify and be responsible for all dimensions. DO NOT scale the drawing - any errors or omissions shall be reported to Stantec. Reproduction or use for any purpose other than that authorized by Stantec is forbidden.

Seal Block

**PRELIMINARY
NOT FOR CONSTRUCTION**
Not for permits, pricing or other official purposes.
This document has not been completed or checked and is for general information or comment only.

Title: PROJECT COVER SHEET
Project No.: 214000361 Scale: 12' = 1'-0"
Revision: Drawing No.:
Issued: By: Appd: YYYY/MM/DD

G001

Notes

Revision By Appd YYYY-MM-DD
50% CD CHECK SET RAH CMG 201.02.17
Issued By Appd YYYY-MM-DD

Permit-Seal

THIS DOCUMENT IS RELEASED FOR THE PURPOSE OF INTERIM REVIEW UNDER THE AUTHORITY OF THE CITY OF UNIVERSITY PARK. ON February 17, 2017. IT IS NOT TO BE USED FOR CONSTRUCTION PURPOSES


Client/Project
Highland Park ISD



University Park ES Rebuild
3505 Amherst Ave Dallas TX 75225

Title




OVERALL SITE PLAN

Project No. 214000361 Scale AS SHOWN
Revision Drawing No.

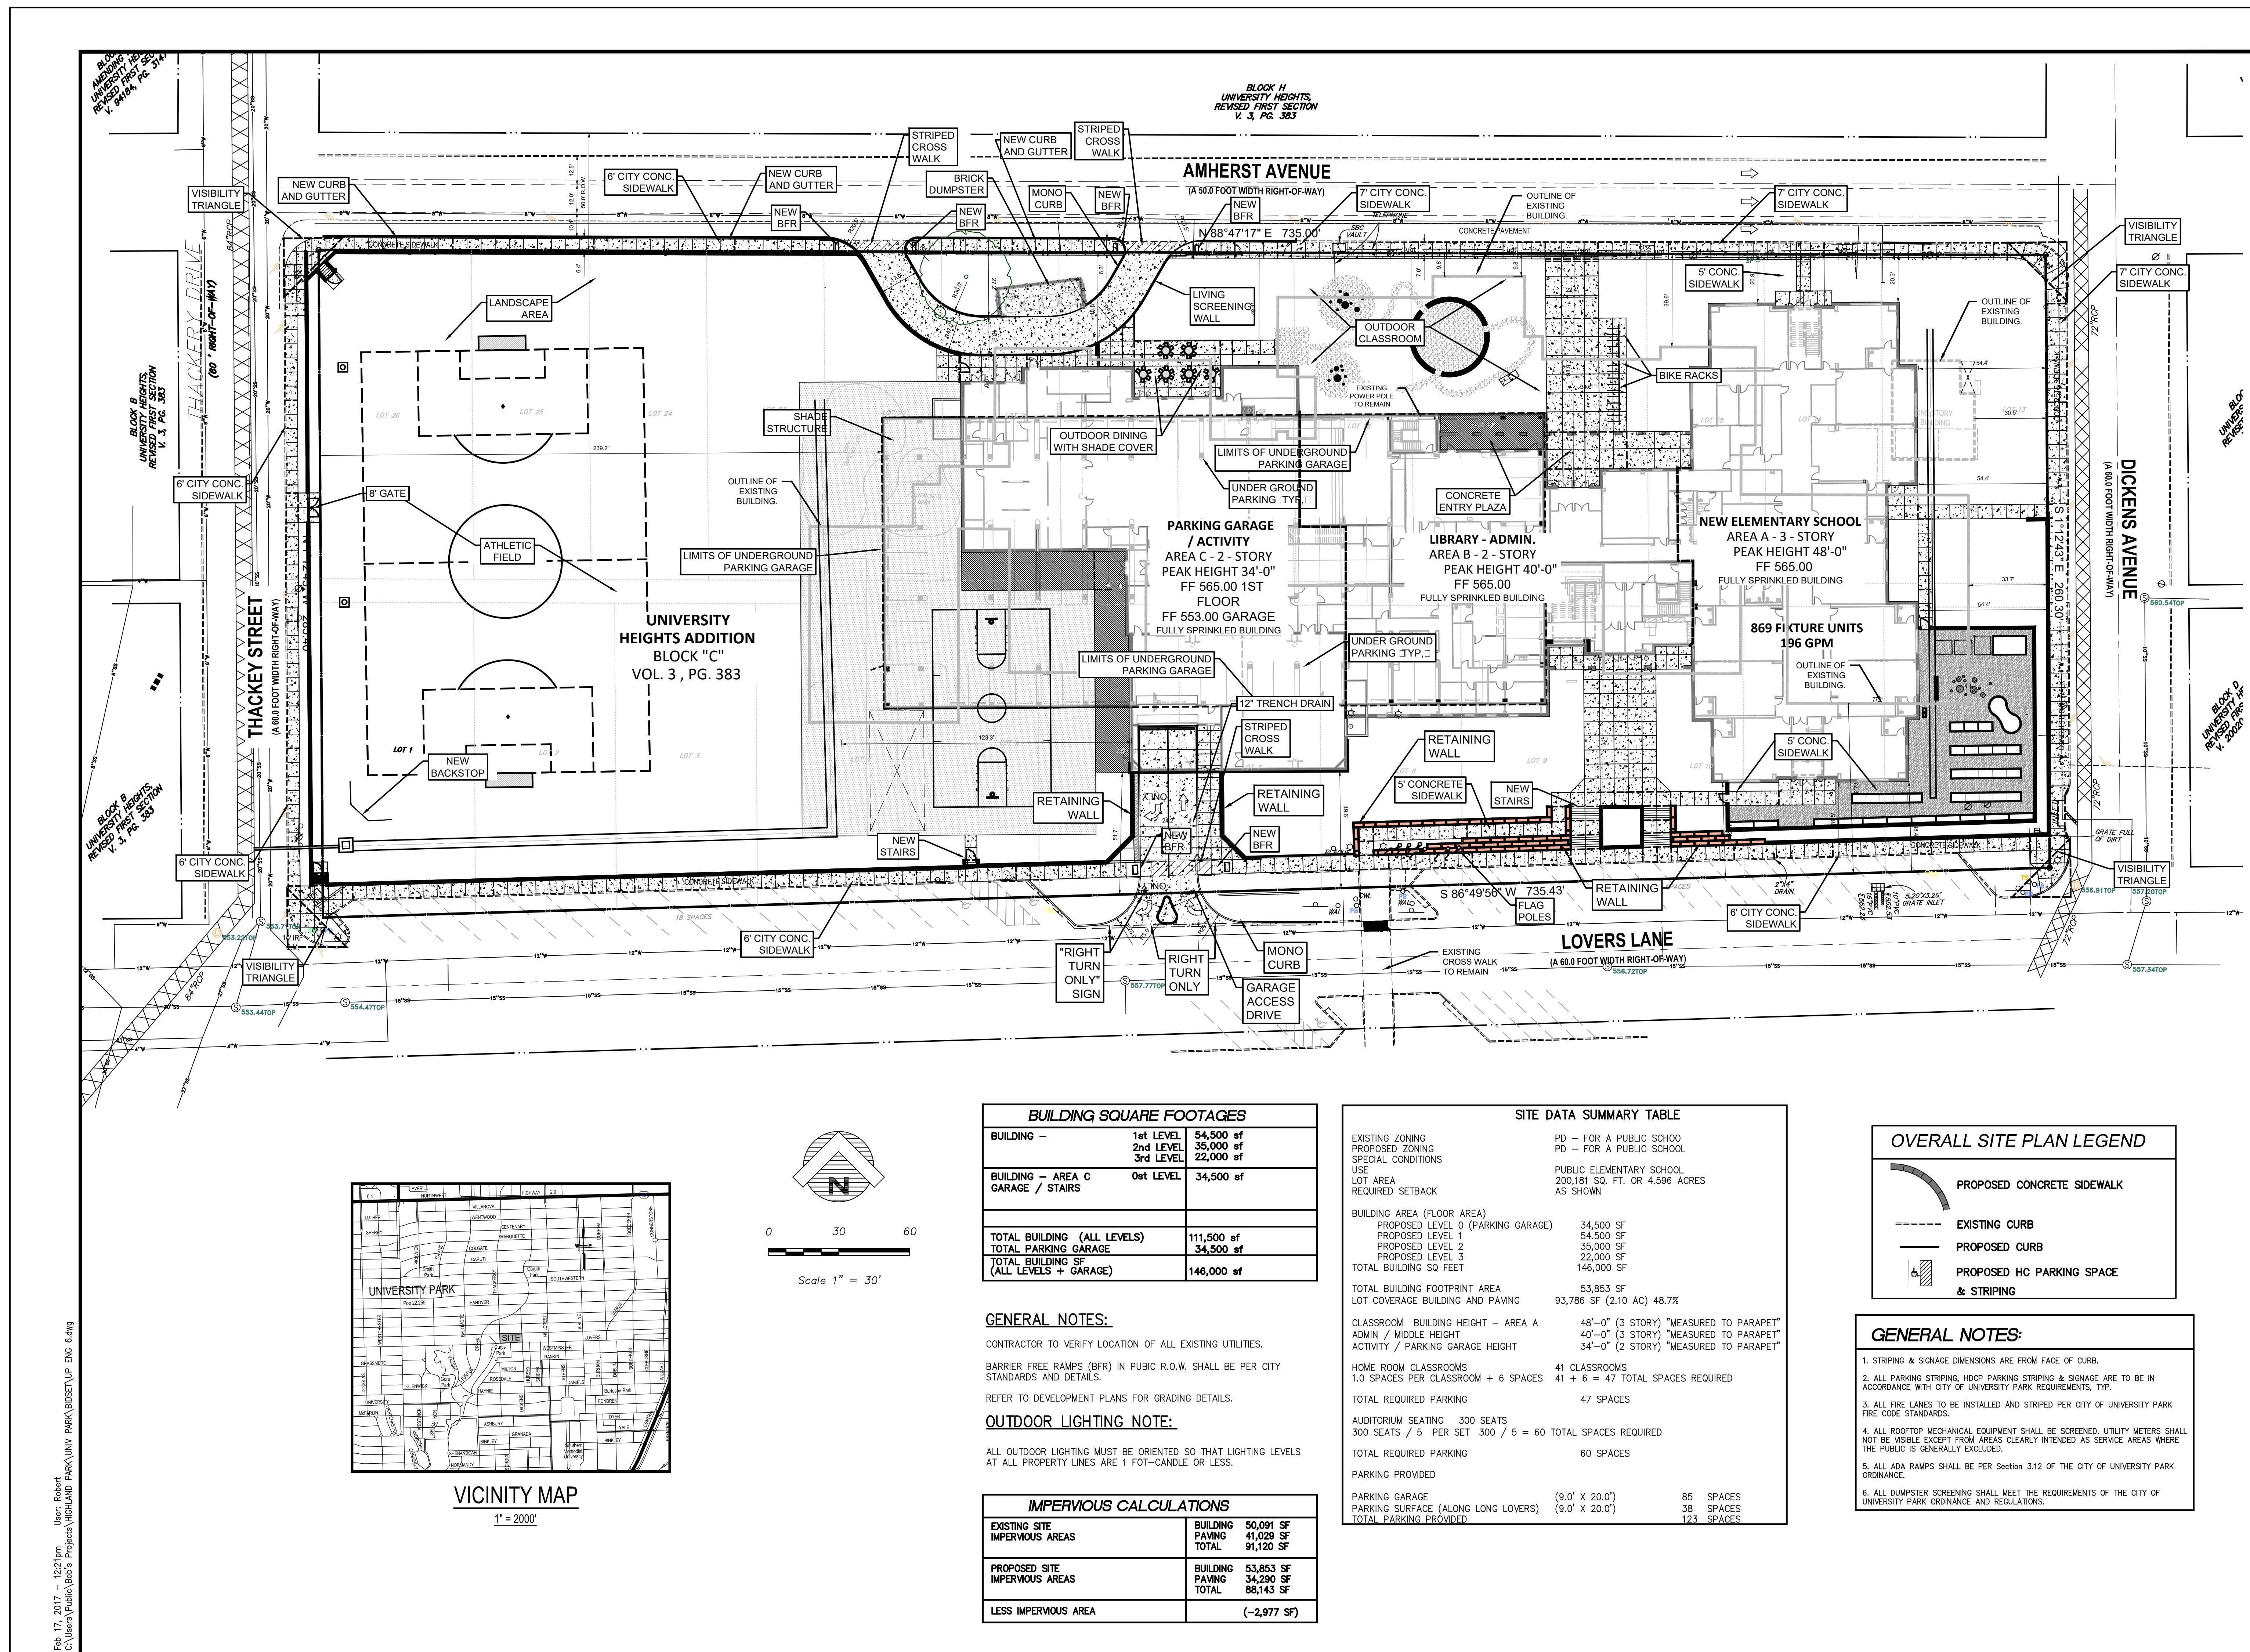

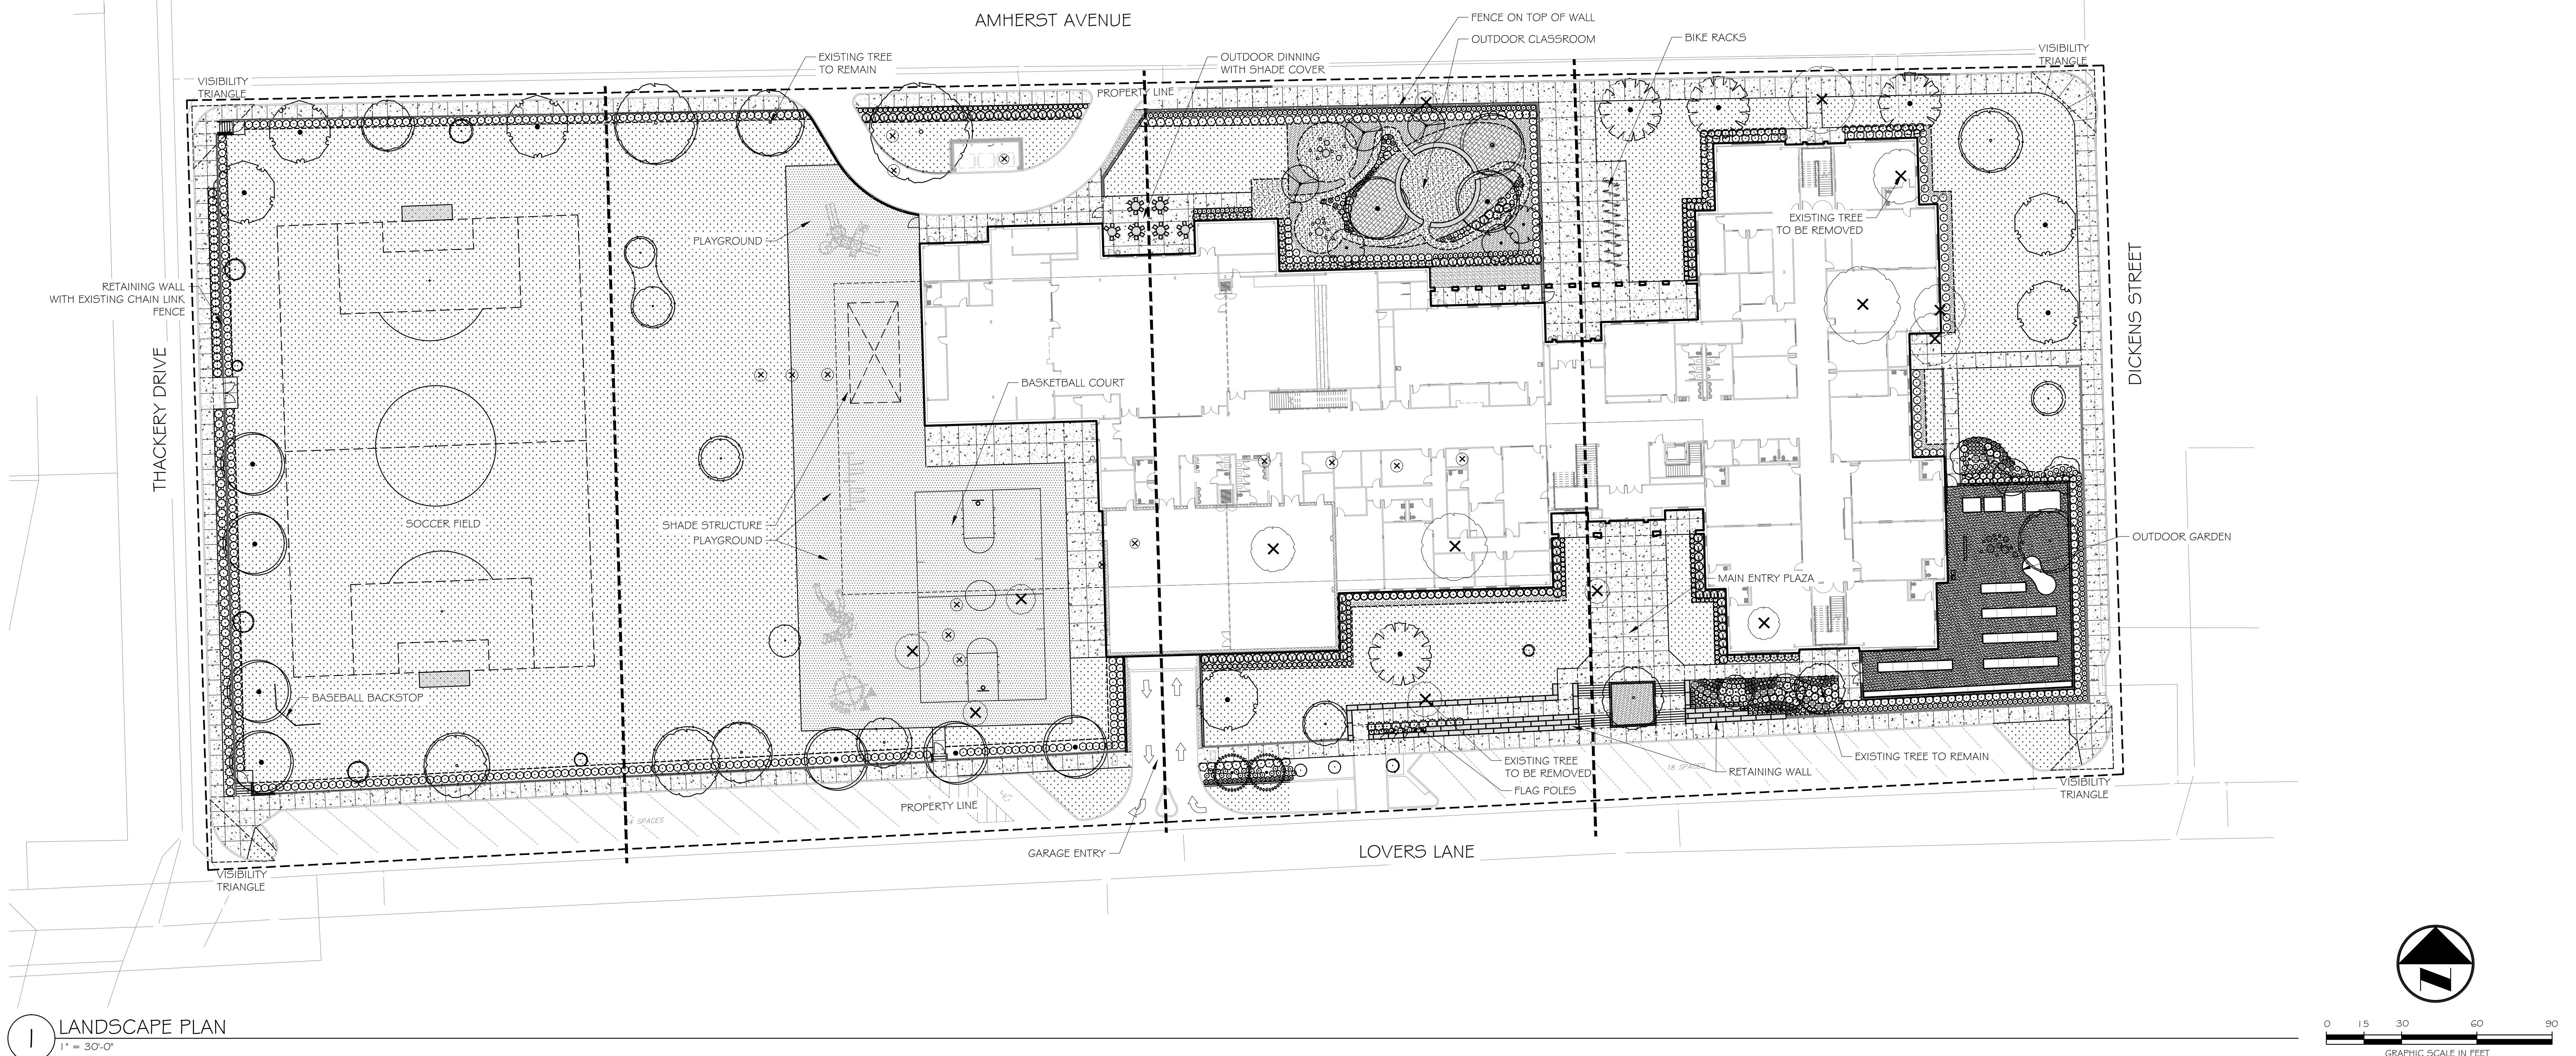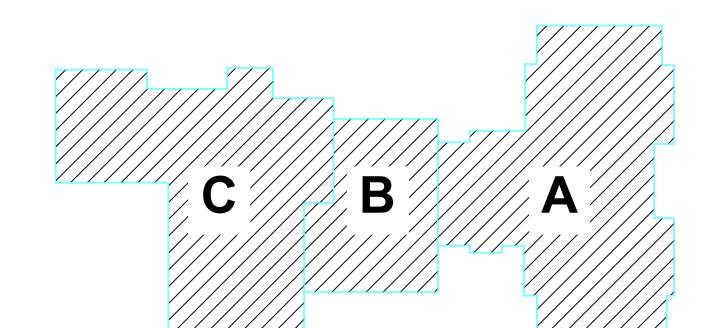

TREE PRESERVATION LEGEND

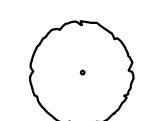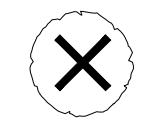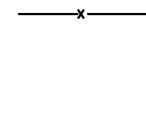-  TREE TO REMAIN
-  TREE TO BE REMOVED
-  TREE PROTECTION FENCE

PLANT SCHEDULE

TREES	BOTANICAL NAME	CONT	CAL	SIZE	REMARKS				
QS	QUERCUS SHUMARDII Shumard Red Oak	B 4 B	6'CAL	10'-12'H X 5'-6'W	SINGLE, STRAIGHT LEADER, MATCHING	PW	PITTOSPORUM TOBIRA 'WHEELERS DWARF' Wheeler's Dwarf Pittosporum	5 GAL	36" o.c. FULL, MATCHING
QV	QUERCUS VIRGINIANA Southern Live Oak	B 4 B	6'CAL	10'-12'H X 5'-6'W	SINGLE, STRAIGHT LEADER, MATCHING	PM2	PODOCARPUS MACROPHYLLUS MAKI Shirley Yew	5 GAL	36" o.c. FULL, MATCHING
UC	ULMUS CRASSIFOLIA Cedar Elm	B 4 B	6'CAL	10'-12'H X 5'-6'W	SINGLE, STRAIGHT LEADER, MATCHING	RI	RHAPHIOLEPIS INDICA Indian Hawthorn	5 GAL	36" o.c. FULL, MATCHING
DT	BOTANICAL NAME DIOSPYROS TEXANA Texas Persimmon	CONT	B 4 B	3'CAL	REMARKS	RT2	ROSMARINUS OFFICINALIS 'TUSCAN BLUE' Tuscan Blue Rosemary	5 GAL	36" o.c. FULL, MATCHING
ILD	ILEX DECIDUA Possumhaw Holly	B 4 B	3'CAL		MULTI-LEADER, FULL, MATCHING	AP	ARTEMISIA X 'POWIS CASTLE' Powis Castle Artemisia	1" GAL	24" o.c. REMARKS DWARF SAGE
LN	LAGERSTROEMIA X 'NATCHEZ' Crape Myrtle	B 4 B	3'CAL		MULTI-TRUNK, FULL, MATCHING	BD	Buddleja Davidii Butterfly Bush	5 GAL	36" o.c. FULL, MATCHING
PM	PRUNUS MEXICANA Mexican Plum	B 4 B	3'CAL		MULTI-TRUNK, FULL, MATCHING	EP2	ECHINACEA PURPUREA Purple Coneflower	1" GAL	18" o.c. FULL, MATCHING
AG2	BOTANICAL NAME ANDROPOGON GLomeratus Bush Beard Grass		SIZE	3" GAL	SPACING	LP2	LANTANA MONTEVIDensis Trailing Lantana	5 GAL	24" o.c. FULL, MATCHING
ID	ILEX CORNUTA 'DWARF BURFORD' Dwarf Burford Holly		7 GAL		24" o.c. REMARKS FULL, MATCHING	LG2	LIATRIS Pycnostachya Gayfeather	1" GAL	18" o.c. FULL, MATCHING
IN	ILEX VOMITORIA 'NANA' Dwarf Yaupon		5 GAL		24" o.c. FULL, MATCHING	PA	PEROVSKIA ATRIPlicifolia Russian Sage	3 GAL	24" o.c. FULL, MATCHING
JB3	JUNIPERUS HORIZONTALIS 'BLUE RUG' Blue Rug Juniper		5 GAL		48" o.c. FULL, MATCHING	RH	RUDBECKIA HIRTA Black-eyed Susan	1" GAL	18" o.c. FULL, MATCHING
LC2	LEUCOPHYLLUM CANDIDUM 'SILVER CLOUD' TM Brewster County Barometerbush		7 GAL		36" o.c. FULL, MATCHING	SH	SALVIA GRIGGII 'HEATWAVE BLAZE' Heatwave Blaze Salvia	1" GAL	24" o.c. FULL, MATCHING
LP	LOROPETALUM CHINENSE Chinese Fringe Flower		5 GAL		42" o.c. FULL, MATCHING	ORNAMENTAL GRASSES NTP	NASSELLA Tenuissima 'PONY TAILS' Mexican Feathergrass	1" GAL	SPACING 18" o.c. REMARKS FULL, MATCHING
MD	MALVAVISCUS DRUMMONDII Turk's Cap		5 GAL		36" o.c. FULL, MATCHING	GROUND COVERS EFC	EUONYMUS FORTUNEI 'COLORATUS' Coloratus Purple Wintercreeper	CONT 4'POT	SPACING 18" o.c. REMARKS FULL, MATCHING
MG2	MUhlenbergia CAPILLaris 'Gulf Coast' Gulf Coast Muhy		5 GAL		36" o.c. FULL, MATCHING	LM	URIOPSE MUSCARI 'BIG BLUE' Lily Turf	4'POT	18" o.c. FULL, MATCHING
MYP	MYRICA PUSILLA Dwarf Southern Wax Myrtle		7 GAL		36" o.c. FULL, MATCHING	SOD/SEED CD	CYNODON DACTYLON Bermuda Grass	CONT SOD'	SPACING REMARKS SOLID, ROLLED TIGHT, SAND FILLED JOINTS, 100% WEED, PEST AND DISEASE FREE
NP	NANDINA DOMESTICA 'FIRE POWER' Firepower Nandina		3 GAL		24" o.c. FULL, MATCHING				

INTERIM REVIEW
THESE DOCUMENTS ARE INTENDED FOR INTERIM REVIEW ONLY AND NOT FOR SUBMISSION TO THE CITY OF DALLAS FOR APPROVAL OR RECORDATION.
REGISTERED LANDSCAPE ARCHITECT: ANNE M. DENNETT LIC. NO. 3146

Client/Project
Highland Park ISD

University Park ES Rebuild

3505 Amherst Ave
Dallas TX 75225

Title
LANDSCAPE PLAN

Project No. 214000361
Scale 1"=30'
Revision Drawing No.



5717 Legacy Drive Suite 250
Plano, TX 75024-4246
Tel: (214) 473-2400 / Fax: (214) 473-2401

www.stantec.com

Copyright Reserved

The Contractor shall verify and be responsible for all dimensions. DO NOT scale the drawing - any errors or omissions shall be reported to Stantec without delay.

The Copyrights to all designs and drawings are the property of Stantec. Reproduction or use for any purpose other than that authorized by Stantec is forbidden.

Consultants



T.B.P.E. FIRM REGISTRATION NO. F - 303
PHONE 972-717-5151 FAX 972-717-2176

33 DECEMBER 2007

Notes

revision	By	Appd	YYYY.
50% CD CHECK SET	RAH	CMG	201
.	By	Appd	YYYY.

Permit-Seal

THIS DOCUMENT IS RELEASED FOR
THE PURPOSE OF INTERIM REVIEW
UNDER THE AUTHORITY OF
MIKE GLENN, P.E. 35059,
ON February 17, 2017
IT IS NOT TO BE USED FOR
CONSTRUCTION PURPOSES

Client/Project
Highland Park ISD


University Park ES Rebuild

Dallas TX 75225

STORM SEWER PLAN

REVISION Drawing No. 3

CU 3

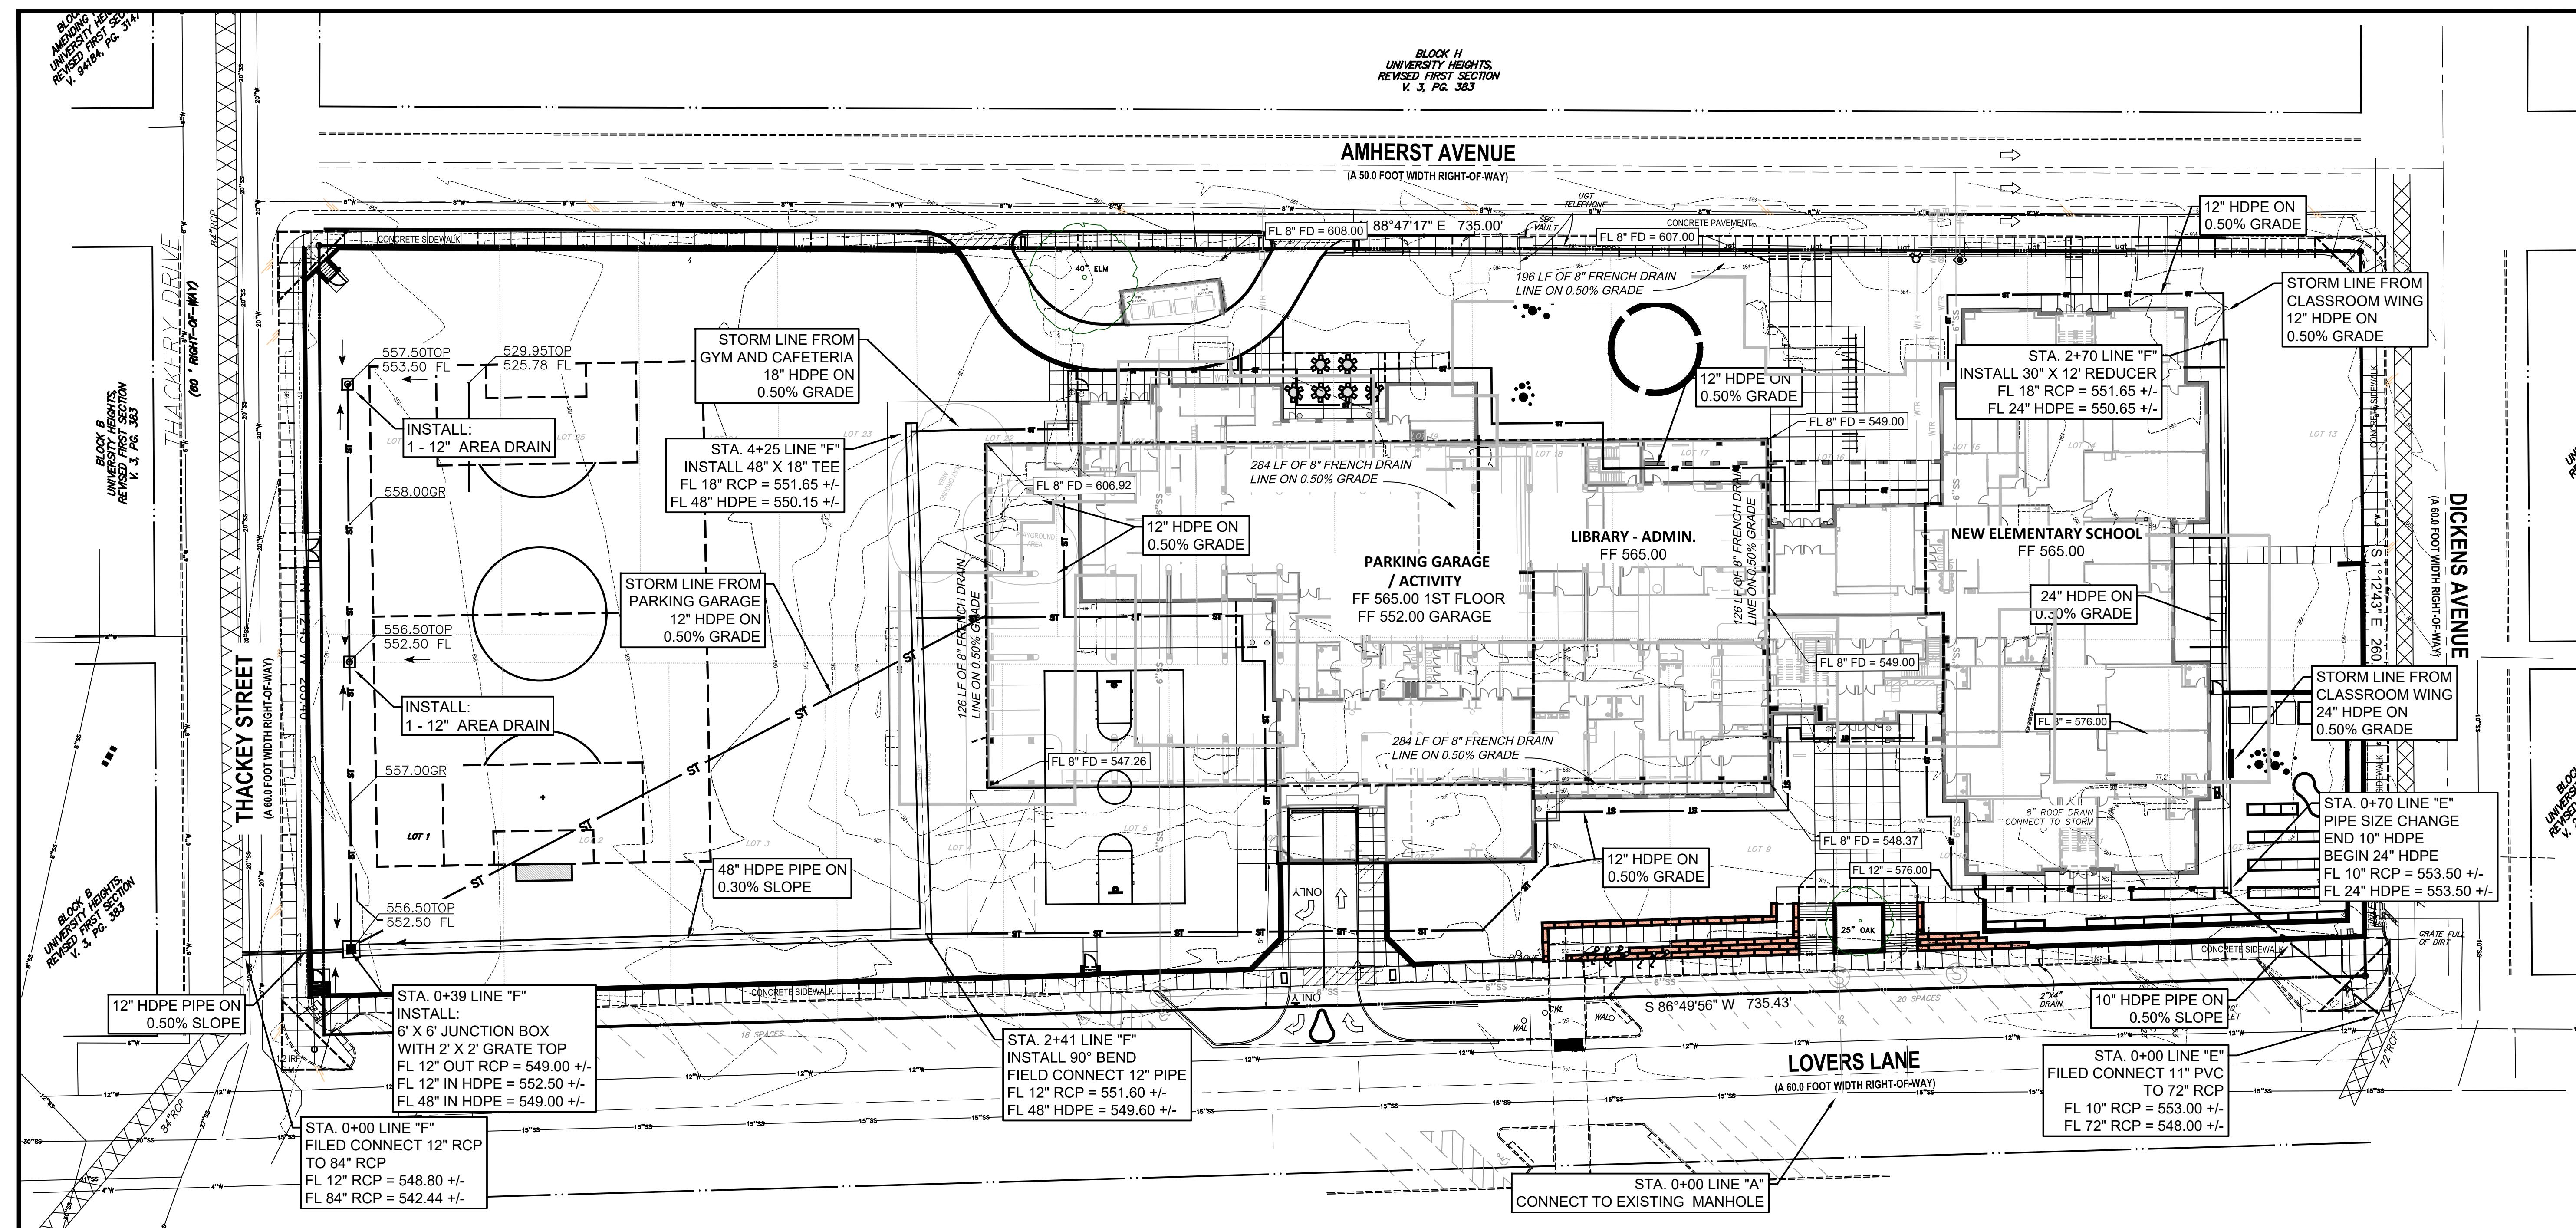

PIPE DETENTION "F" CALCULATIONS

PEAK ALLOWABLE DISCHARGE - 12" RCP OUTLET CONTROL.	6.16 CFS
PEAK INFLOW - AREAS "A" AND "F" (6.4 + 7.0)	13.4 CFS
FLOW RATE DETAINED.	7.24 CFS
STORAGE REQUIRED.	3,571 CU. FT.
STORAGE PROVIDED	7,815 CU. FT.

A horizontal scale bar with tick marks at 0, 30, and 60.

PIPE RETENTION "E" CALCULATION


PEAK ALLOWABLE DISCHARGE - 10" RCP OUTLET CONTROL	2.31 CFS
PEAK INFLOW - AREA "E" (2.6)	3.40 CFS
FLOW RATE DETAINED.	1.09 CFS
STORAGE REQUIRED.	555 CFS
STORAGE REQUIRED.	1,075 CFS


**CONTRACTOR SHALL VERIFY ALL EXISTING INVERTS,
LOCATIONS AND ELEVATIONS PRIOR TO CONSTRUCTION**

GENERAL STORM SEWER NOTES:

1. ALL CONSTRUCTION TO BE IN ACCORDANCE WITH THESE PLANS AND CITY OF UNIVERSITY PARK STANDARDS AND SPECIFICATIONS.
 2. PRIOR TO STARTING CONSTRUCTION, THE CONTRACTOR SHALL MAKE CERTAIN THAT ALL REQUIRED PERMITS AND APPROVALS HAVE BEEN OBTAINED. NO CONSTRUCTION OR FABRICATION SHALL BEGIN UNTIL THE CONTRACTOR HAS RECEIVED AND THOROUGHLY REVIEWED ALL PLANS AND OTHER DOCUMENTS APPROVED BY ALL OF THE PERMITTING AUTHORITIES.
 3. ALL WORK SHALL BE PERFORMED IN ACCORDANCE WITH THESE PLANS AND SPECIFICATIONS AND THE REQUIREMENTS AND STANDARDS OF THE LOCAL GOVERNING AUTHORITY.
 4. IN THE EVENT AN ITEM IS NOT COVERED IN THE CITY OF UNIVERSITY PARK SPECIFICATIONS, THE ENGINEER'S DECISION SHALL APPLY.
 5. BARRICADING, TRAFFIC CONTROL, AND PROJECT SIGNS SHALL CONFORM TO "STATE DEPARTMENT OF HIGHWAYS AND PUBLIC TRANSPORTATION BARRICADING AND CONSTRUCTION STANDARDS".
 6. THE GENERAL CONTRACTOR AND ALL SUB-CONTRACTORS SHALL VERIFY THE SUITABILITY OF ALL EXISTING AND PROPOSED SITE CONDITIONS INCLUDING GRADES AND DIMENSIONS BEFORE COMMENCEMENT OF ANY CONSTRUCTION. IN THE EVENT OF ANY CONFLICT AND PRIOR TO COMMENCEMENT OF ANY CONSTRUCTION, IMMEDIATELY NOTIFY ENGINEER. MINOR ADJUSTMENTS OF FINISH GRADE TO ACCOMPLISH SPOT DRAINAGE ARE ACCEPTABLE, IF NECESSARY, UPON PRIOR APPROVAL OF ENGINEER. PAVING INSTALLED SHALL 'FLUSH OUT' AT ANY JUNCTURE WITH EXISTING PAVING.
 7. THE LOCATIONS OF UNDERGROUND UTILITIES SHOWN ON THIS PLAN ARE BASED ON FIELD SURVEYS AND LOCAL UTILITY COMPANY RECORDS. IT SHALL BE THE CONTRACTOR'S FULL RESPONSIBILITY TO CONTACT THE VARIOUS UTILITY COMPANIES TO LOCATE THEIR UTILITIES PRIOR TO STARTING CONSTRUCTION.
 8. CONTRACTOR SHALL VERIFY ALL EXISTING INVERTS, RIM ELEVATIONS AND SIZES PRIOR TO CONSTRUCTION.
 9. ALL NON RCP DRAIN PIPE SHALL BE PVC SCH 40, ADS OR APPROVED EQUAL.
 10. ALL RCP SHALL BE CLASS III.
 11. W.E. AS INDICATED ON INLET CALLS INDICATES WATER ELEVATION AT INLET DURING 100 YEAR STORM EVENT.
 12. "DESIGN INTENT SHALL BE TO CREATE AN ON SITE STORM SEWER SYSTEM THAT, WHEN TIED INTO THE CITY STORM SYSTEM, DOES NOT OVER BURDEN THE CITY STORM SYSTEM WHEN COMPARED TO THE OUTFLOW OF THE EXISTING FACILITY."
 13. THE PROPOSED IMPERVIOUS AREA WILL BE EQUAL TO OR LESS THAN THE EXISTING IMPERVIOUS AREA..

NOTE: THE CITY OF UNIVERSITY PARK CONSTRUCTION STANDARDS APPLY, WHETHER INDICATED ON THESE PLANS OR NOT.

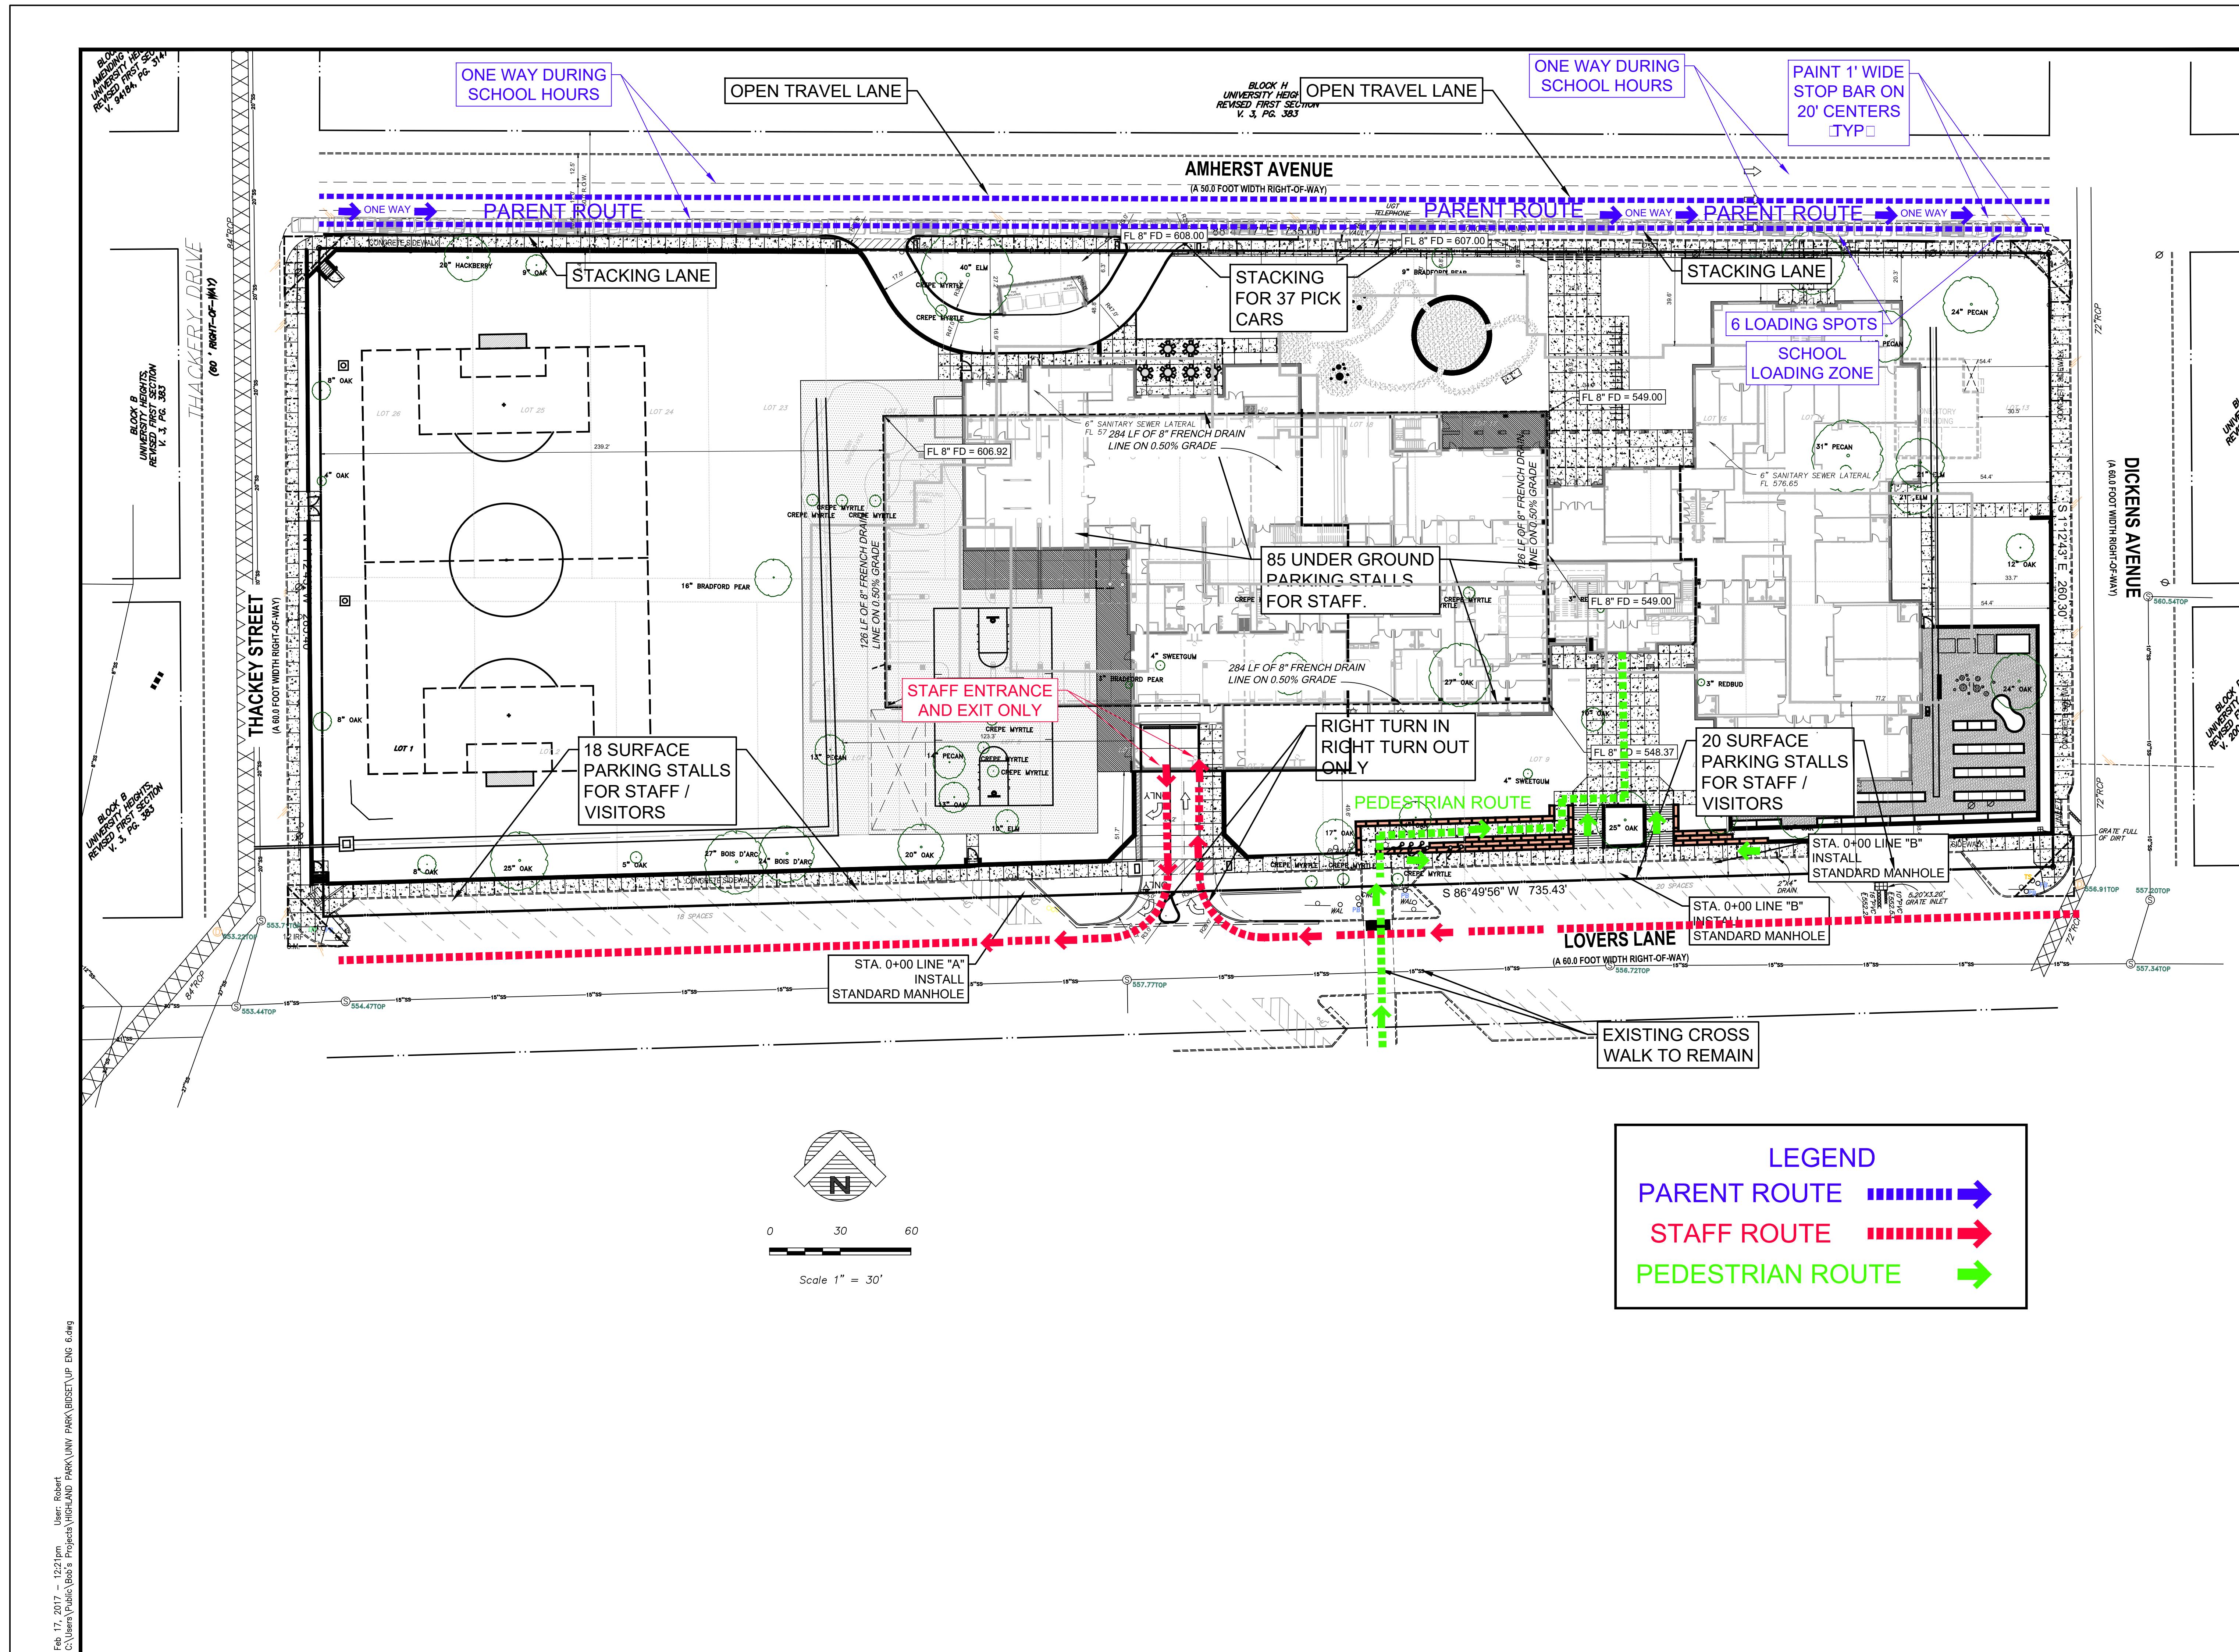

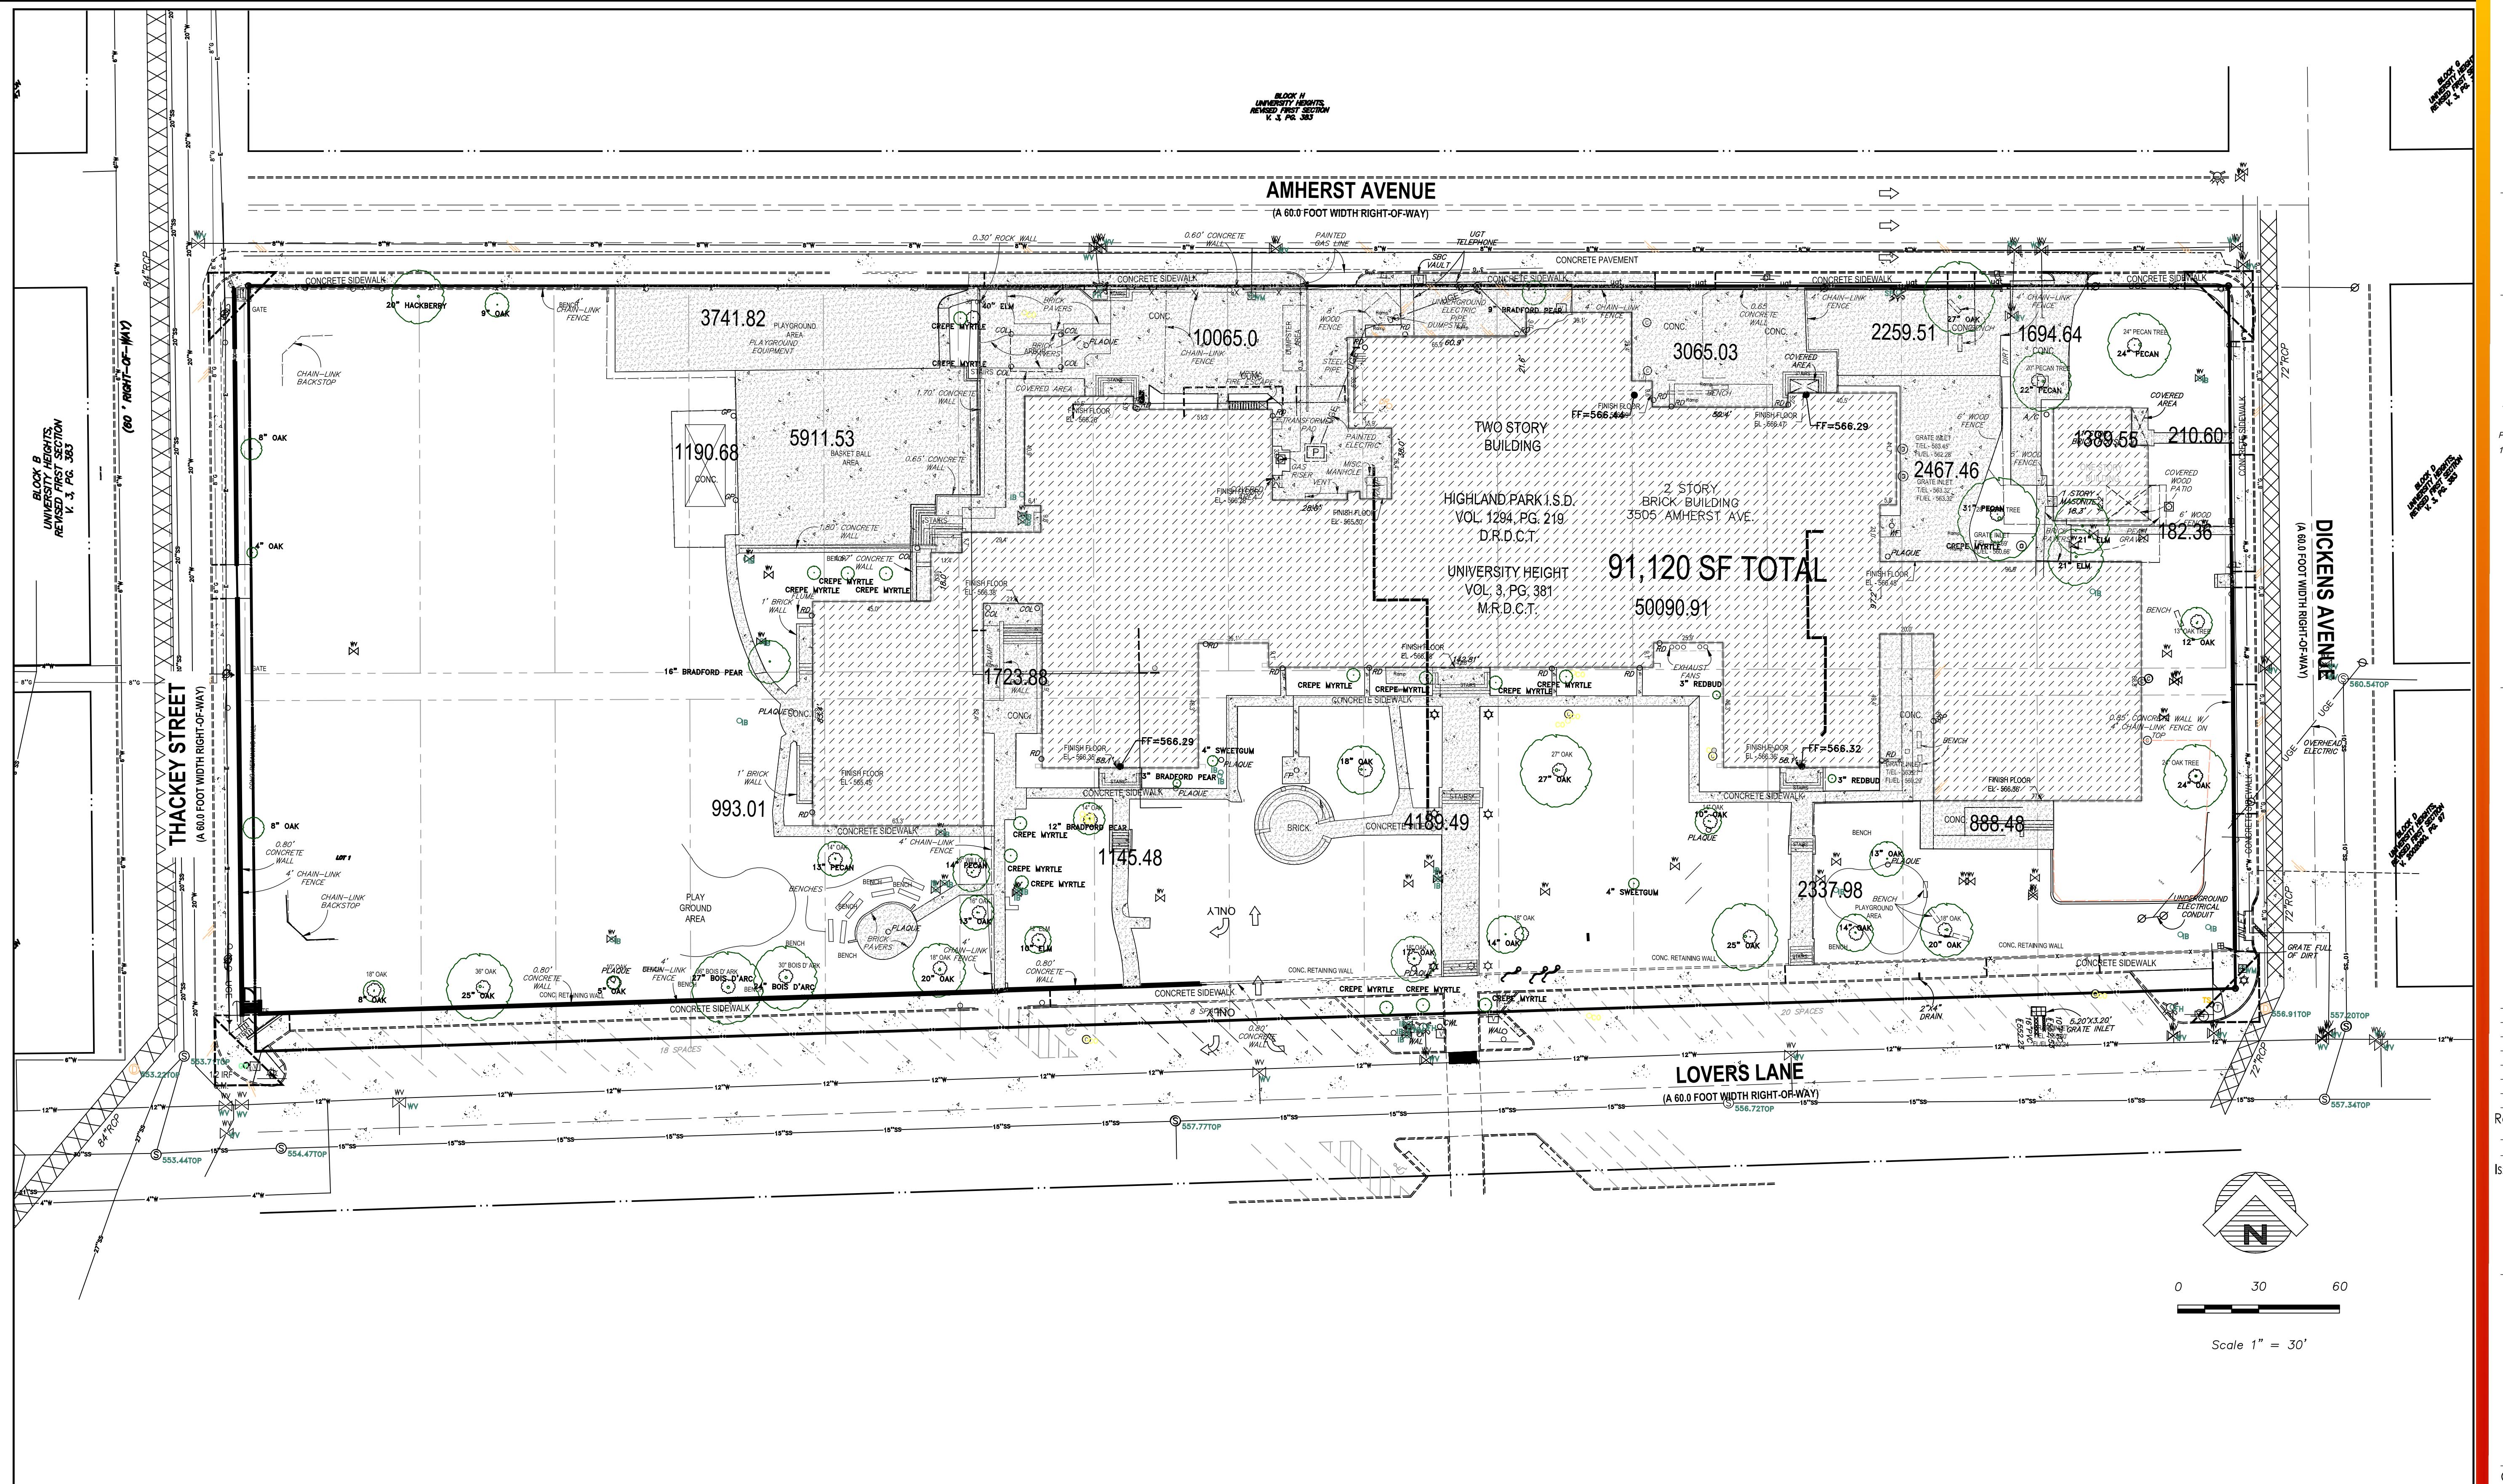

THIS DOCUMENT IS RELEASED FOR
THE PURPOSE OF INTERIM REVIEW
UNDER THE AUTHORITY OF
MIKE GLENN, P.E. 35059,
ON December 21, 2016
IT IS NOT TO BE USED FOR
CONSTRUCTION PURPOSES

Client/Project
Highland Park ISD

University Park ES Rebuild

3505 Amherst Ave
Dallas TX 75225

Title
**EXISTING IMPERVIOUS
CALCULATION WORKSHEET**

Project No. 214000361 Scale AS SHOWN
Revision Drawing No.

CD 1.0

Notes

Revision By Appd YYYY/MM/DD
50% CD CHECK SET RAH CMG 201.02.17
Issued By Appd YYYY/MM/DD

Permit-Seal


THIS DOCUMENT IS RELEASED FOR THE PURPOSE OF RECORD REVIEW
UNDER THE AUTHORITY OF
MIKE GLENN, P.E. 35059
ON February 17, 2017
IT IS NOT TO BE USED FOR CONSTRUCTION PURPOSES

Client/Project
Highland Park ISD

University Park ES Rebuild
3505 Amherst Ave
Dallas TX 75225


Title

PROPOSED DA MAP
Project No. 214000361
Scale AS SHOWN
Revision Drawing No.

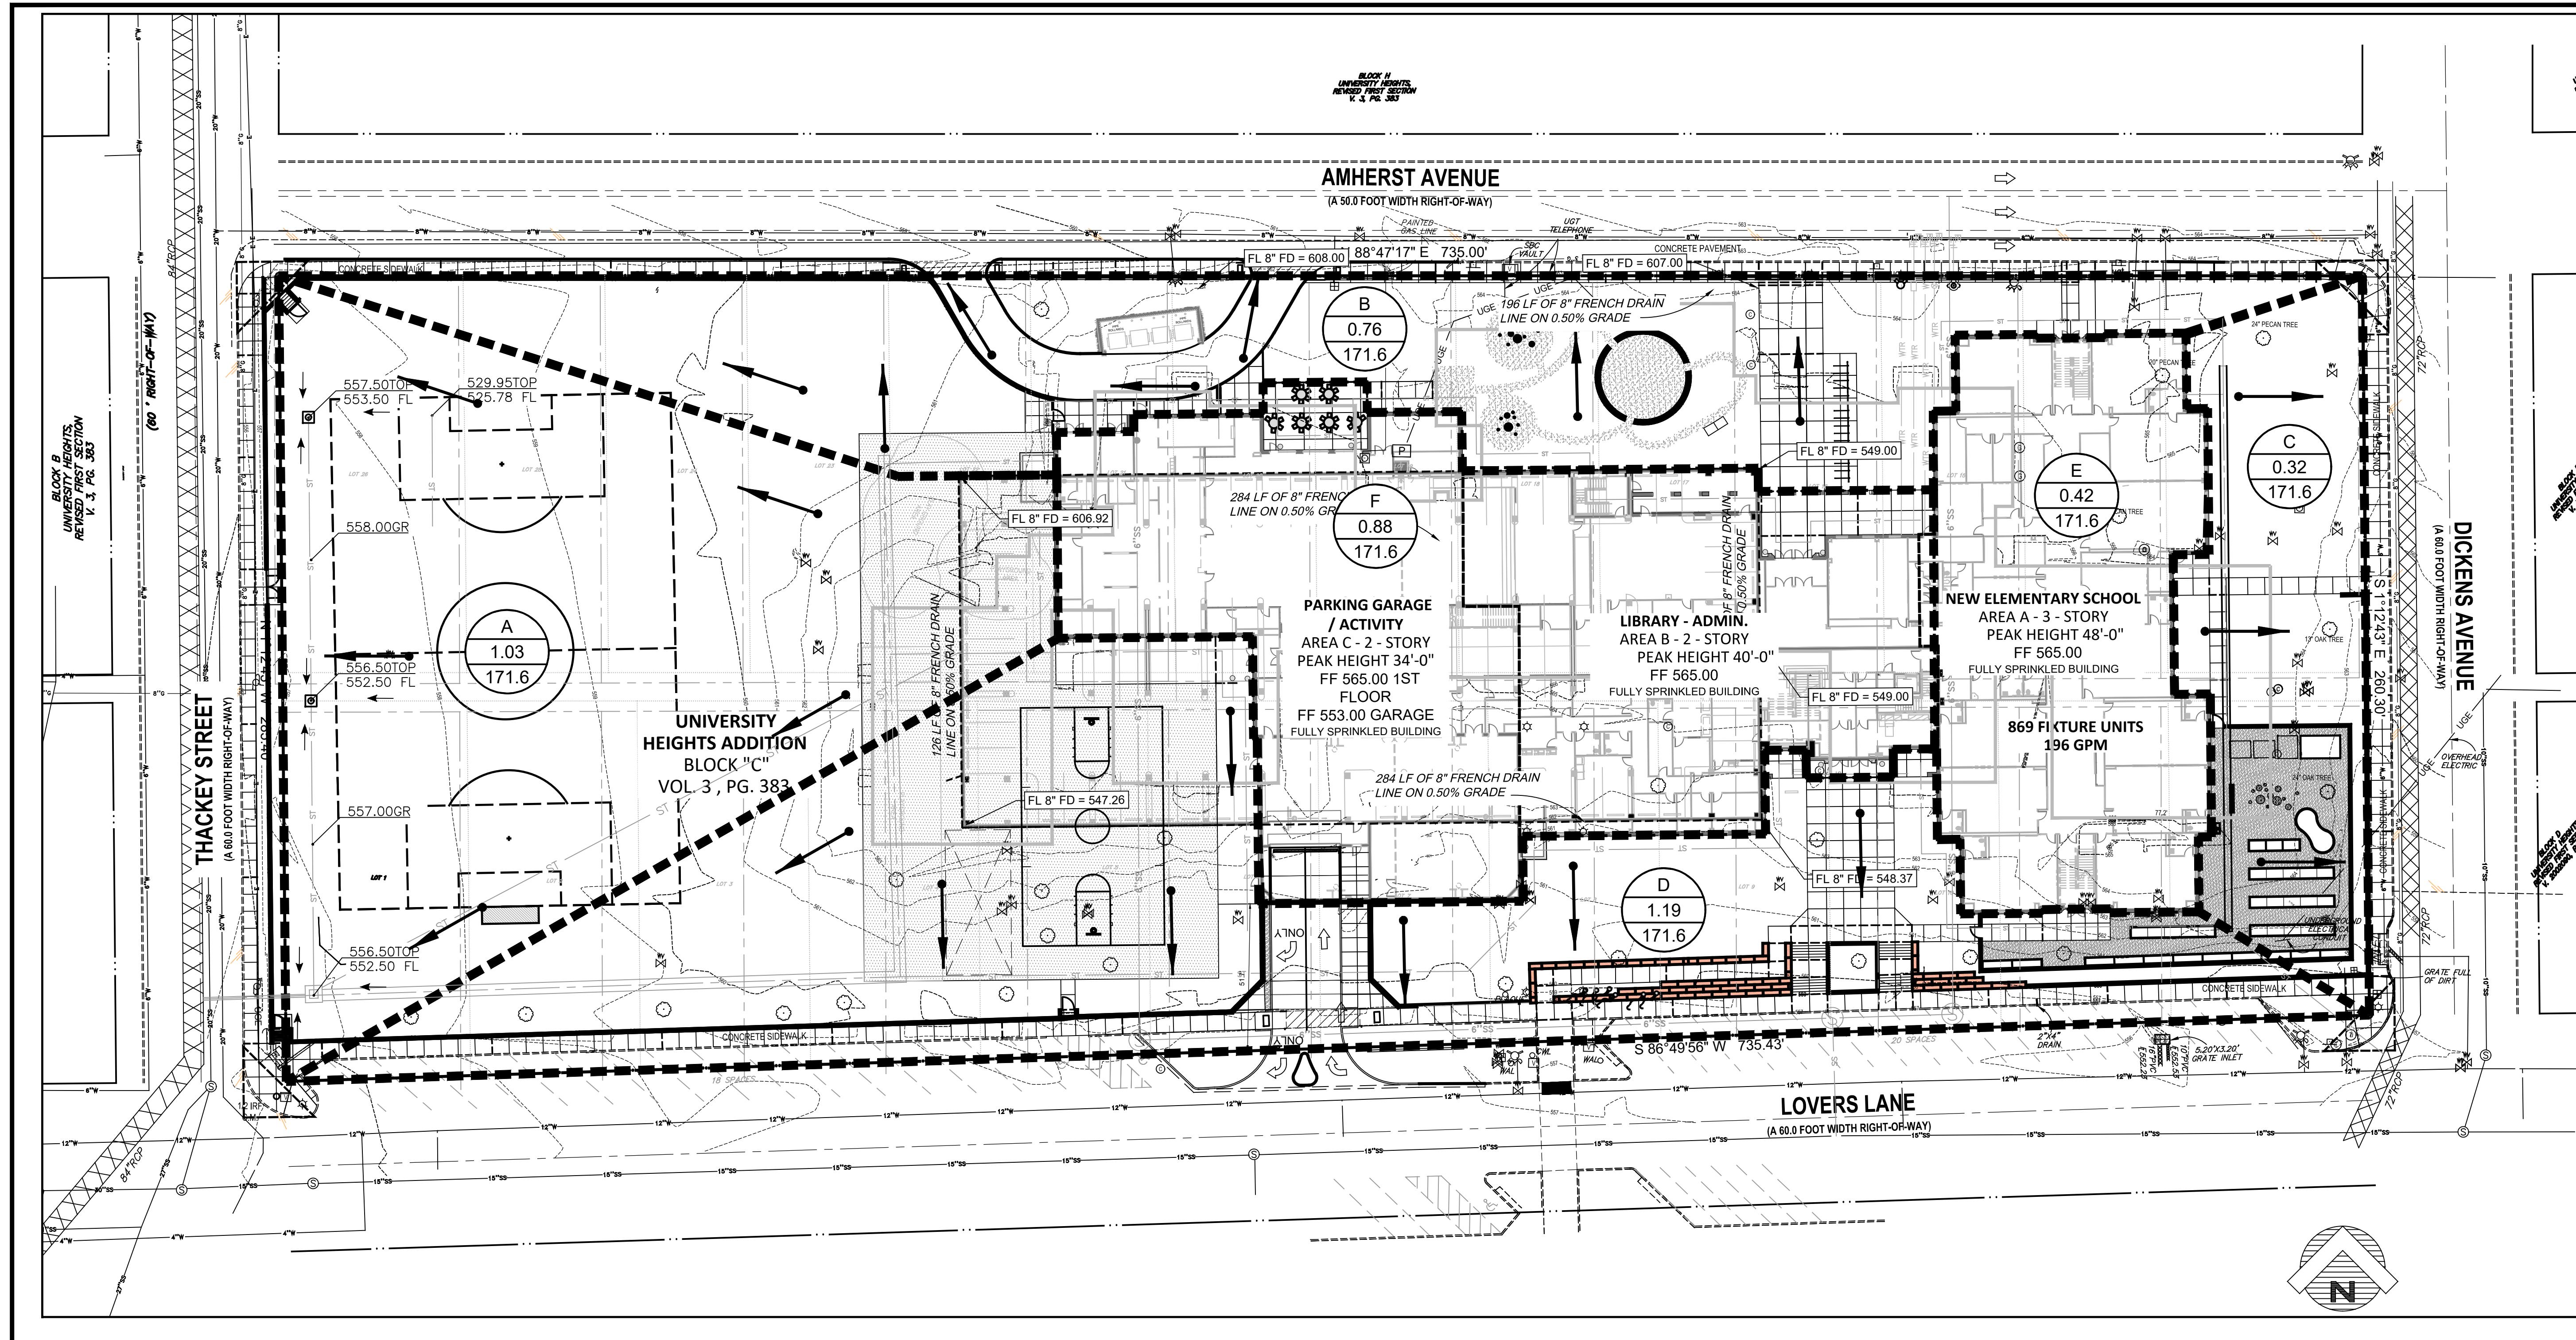


POST DEVELOPMENT RUNOFF CALCULATIONS - UNIVERSITY PARK ELEMENTARY SCHOOL								
AREA ID	DRAINAGE AREA (ACRES)	RUNOFF COEFFICIENT "C"	C*A	TIME OF CONCENTRATION MINUTES	INTENSITY "100"	DESIGN FLOW "Q.100" (CFS)	DRAINS TO / REMARKS	
A	1.03	0.70	0.72	10	8.88	6.4	TO BASIN	
B	0.76	0.70	0.53	10	8.88	4.7	SURFACE FLOW TO THACKEY STREET	
C	0.32	0.70	0.22	10	8.88	2.0	SURFACE FLOW TO AMHERST STREET	
D	1.19	0.70	0.83	10	8.88	7.4	SURFACE FLOW TO DICKENS STREET	
E	0.42	0.90	0.38	10	8.88	3.4	SURFACE FLOW TO LOVERS LANE	
F	0.88	0.90	0.79	10	8.88	7.0	ROOF DRAIN TO BASIN "E" ROOF DRAIN TO BASIN "F"	
SUM OF "A" AREAS		SUM OF "A" AREAS		"Q100"		30.9		

NOTES:

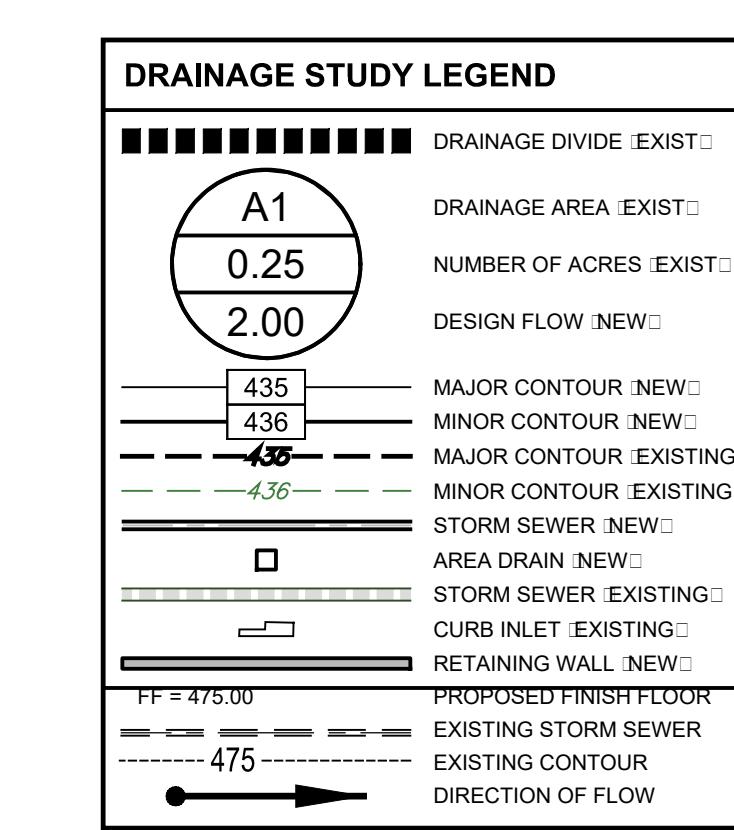

TOTAL DISTURBED ACRES
DISTURBED ACRES: 45.15

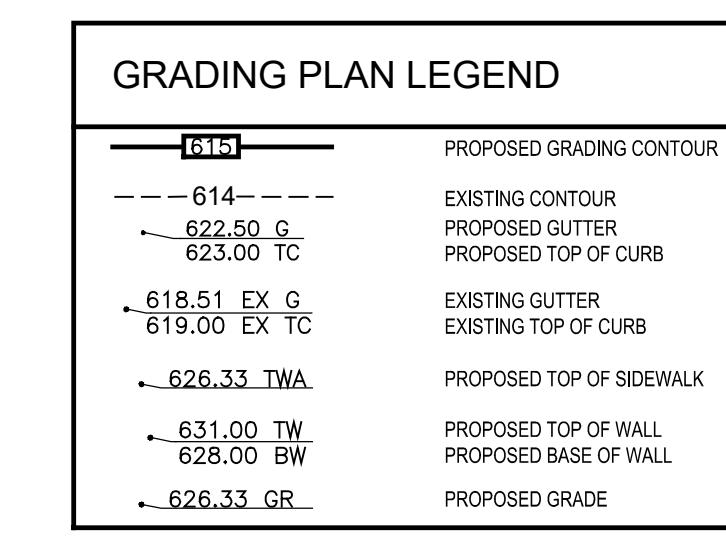



5717 Legacy Drive Suite 250
Plano, TX 75024-4246
Tel: (214) 473-2400 / Fax: (214) 473-2401

www.stantec.com

Copyright Reserved

The Contractor shall verify and be responsible for all dimensions. DO NOT scale the drawing - any errors or omissions shall be reported to Stantec.

The Copyrights of all designs and drawings are the property of Stantec. Reproduction or use for any purpose other than that authorized by Stantec is forbidden.

Consultants



T.B.P.E. FIRM REGISTRATION NO. F - 303

PHONE 972-717-5151 FAX 972-717-2176

105 DECKER COURT SUITE 910 IRVING, TEXAS 75062

Notes

PIPE DETENTION "E" CALCULATIONS

PEAK ALLOWABLE DISCHARGE = 10" RCP OUTLET CONTROL	2.31 CFS
PEAK INFLOW = AREA "E" (2.6)	3.40 CFS
FLOW RATE DETAINED	1.09 CFS
STORAGE REQUIRED	555 CU. FT.
STORAGE PROVIDED	1,958 CU. FT.

Revision By Appd YYYYMMDD

50% CD CHECK SET RAH CMG 201.02.17

Issued By Appd YYYYMMDD

Permit-Seal

THIS DOCUMENT IS RELEASED FOR THE PURPOSE OF INTERIM REVIEW
BY THE AUTHORITY OF
MIKE GLENN, P.E. 350597
ON February 17, 2017
IT IS NOT TO BE USED FOR CONSTRUCTION PURPOSES

Client/Project
Highland Park ISD

University Park ES Rebuild
3505 Amherst Ave
Dallas TX 75225


Title
PROPOSED DRAINAGE CALCULATIONS BASIN "E"


Project No. 214000361 Scale AS SHOWN

Revision Drawing No.

PIPE BASIN "E" CALCULATIONS


NOTE: THE CITY OF UNIVERSITY PARK CONSTRUCTION STANDARDS APPLY, WHETHER INDICATED ON THESE PLANS OR NOT.

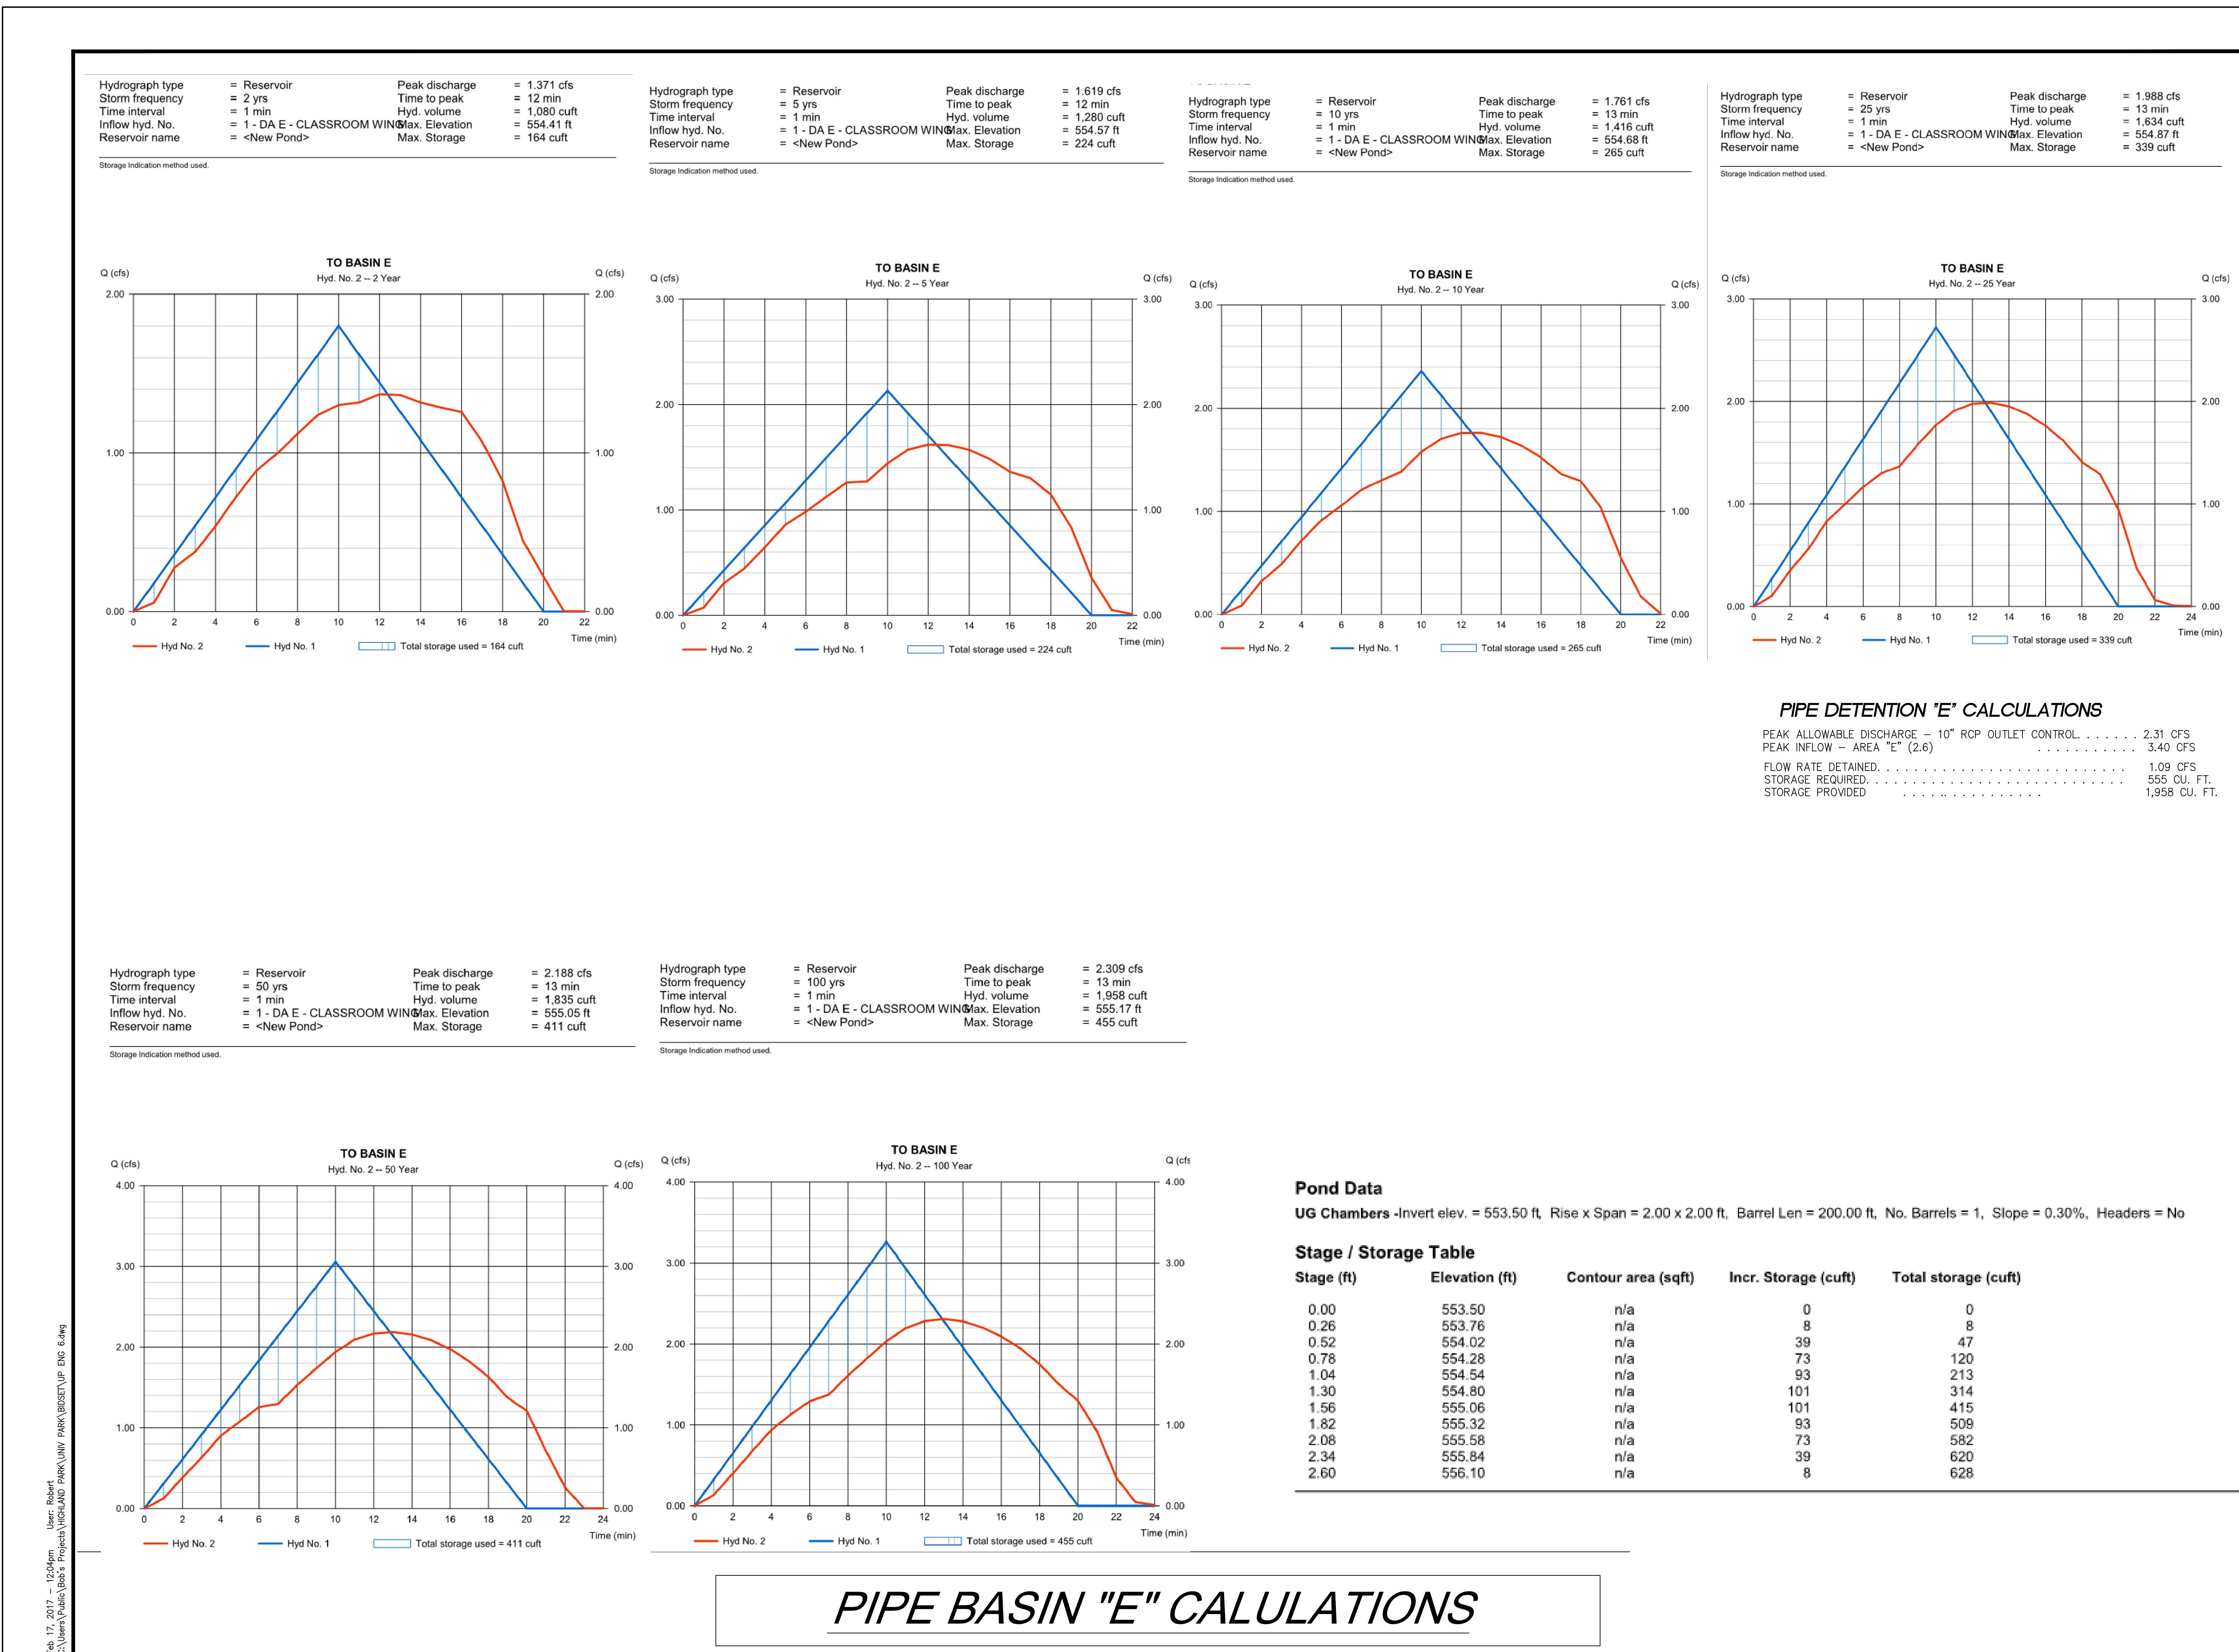

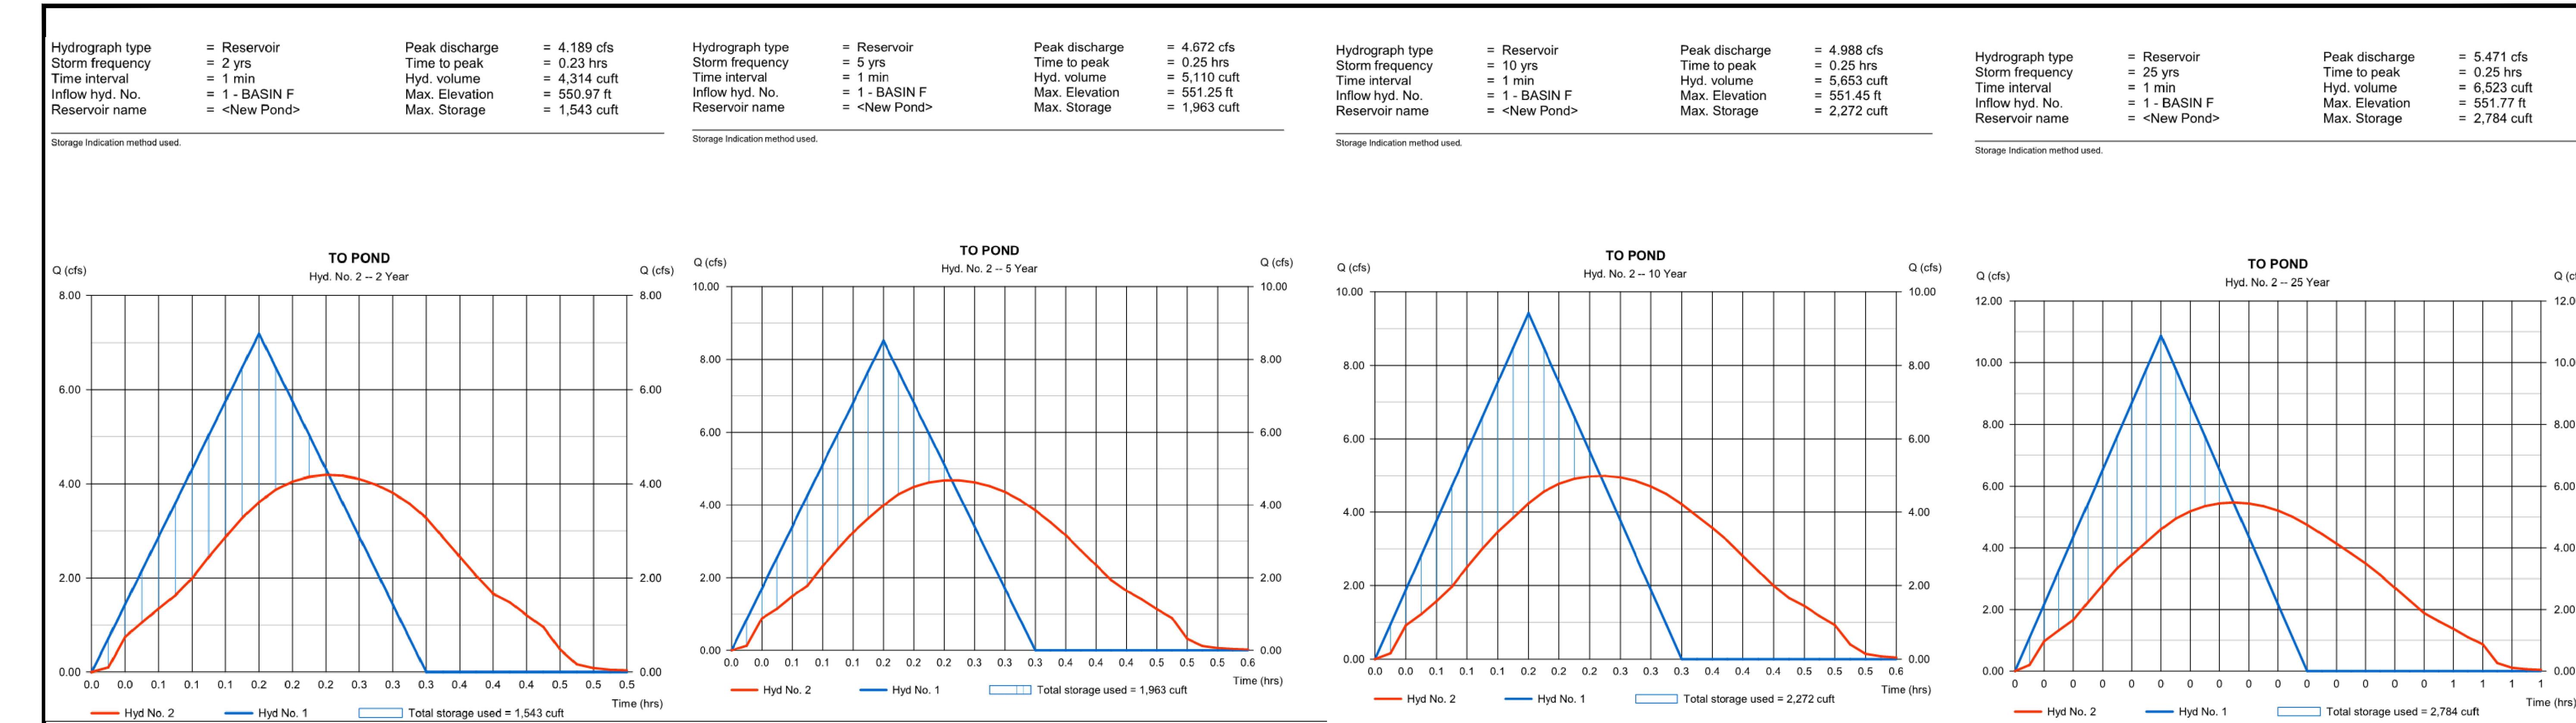

Hydrograph type = Reservoir Storm frequency = 50 yrs Time interval = 1 min Inflow hyd. No. = 1 - BASIN F Reservoir name = <New Pond>	Peak discharge = 5,894 cfs Time to peak = 0.25 hrs Hyd. volume = 7,325 cuft Max. Elevation = 552.09 ft Max. Storage = 3,270 cuft
Hydrograph type = Reservoir Storm frequency = 100 yrs Time interval = 1 min Inflow hyd. No. = 1 - BASIN F Reservoir name = <New Pond>	Peak discharge = 6,157 cfs Time to peak = 0.25 hrs Hyd. volume = 7,815 cuft Max. Elevation = 552.30 ft Max. Storage = 3,571 cuft

Storage Indication method used.

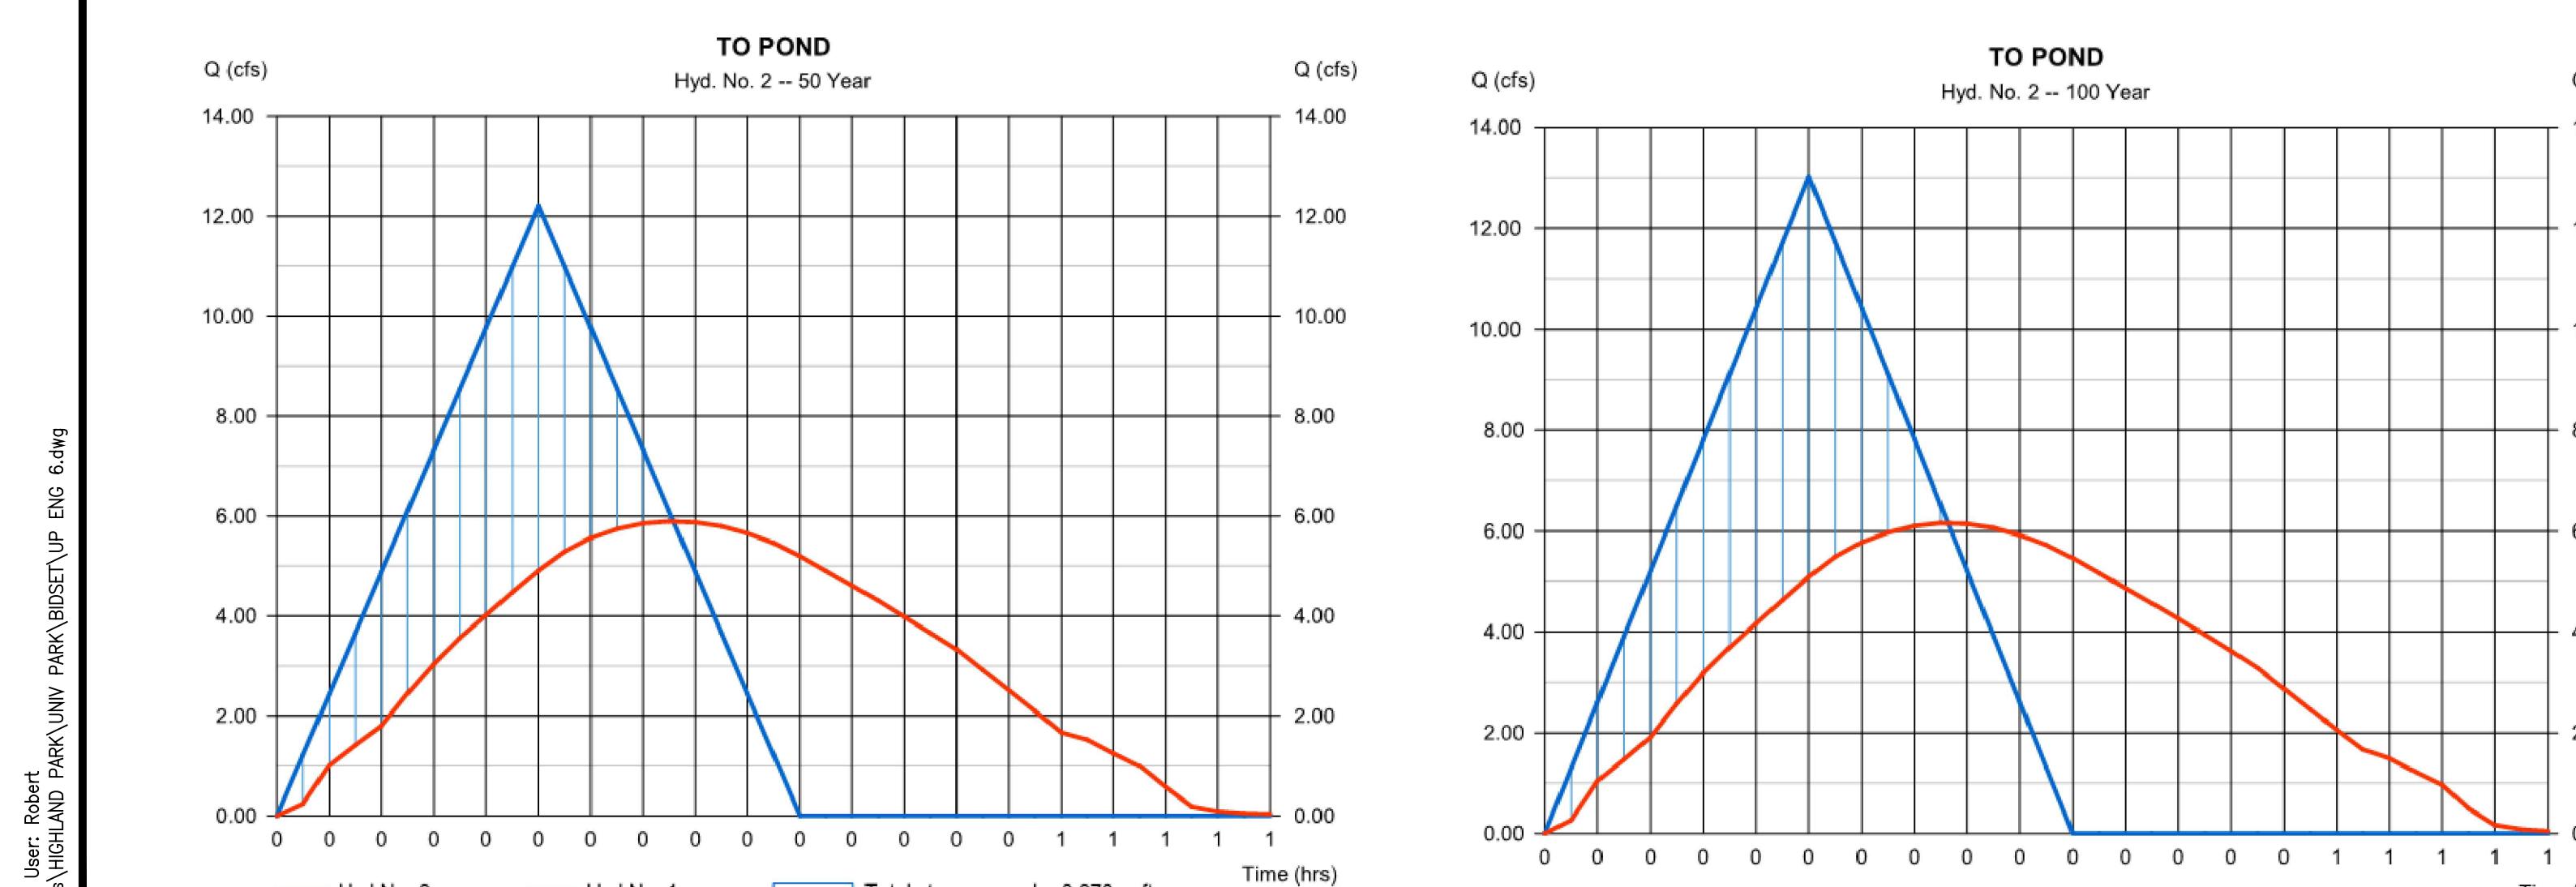

Pond Data

UG Chambers -Invert elev. = 549.00 ft, Rise x Span = 4.00 x 4.00 ft, Barrel Len = 400.00 ft, No. Barrels = 1, Slope = 0.30%, Headers = No

Stage / Storage Table

Stage (ft)	Elevation (ft)	Contour area (sqft)	Incr. Storage (cuft)	Total storage (cuft)
0.00	549.00	n/a	0	0
0.52	549.52	n/a	64	64
1.04	550.04	n/a	310	374
1.56	550.56	n/a	584	959
2.08	551.08	n/a	746	1,705
2.60	551.60	n/a	810	2,515
3.12	552.12	n/a	809	3,324
3.64	552.64	n/a	746	4,070
4.16	553.16	n/a	584	4,654
4.68	553.68	n/a	309	4,964
5.20	554.20	n/a	64	5,028

PIPE BASIN "F" CALCULATIONS

NOTE: THE CITY OF UNIVERSITY PARK CONSTRUCTION STANDARDS APPLY, WHETHER INDICATED ON THESE PLANS OR NOT.



Copyright Reserved

The Contractor shall verify and be responsible for all dimensions. DO NOT scale the drawing - any errors or omissions shall be reported to Stantec.

The Copyrights to all designs and drawings are the property of Stantec. Reproduction or use for any purpose other than that authorized by Stantec is forbidden.

Consultants



Notes

PIPE DETENTION "F" CALCULATIONS

PEAK ALLOWABLE DISCHARGE - 12" RCP OUTLET CONTROL	6.16 CFS
PEAK INFLOW - AREAS "A" AND "F" (6.4 + 7.0) .	13.4 CFS
FLOW RATE DETAILED	7.24 CFS
STORAGE REQUIRED	3,571 CU. FT.
STORAGE PROVIDED	7,815 CU. FT.

Revision

50% CD CHECK SET By RAH Appd YYYYMMDD
Issued By CMG Appd YYYYMMDD

Permit-Seal

THIS DOCUMENT IS RELEASED FOR THE PURPOSE OF INTERIM REVIEW AND USE BY THE AUTHORITY OF MIKE GLENN, P.E. 350597
ON FEBRUARY 17, 2012.
IT IS NOT TO BE USED FOR CONSTRUCTION PURPOSES



Client/Project
Highland Park ISD

University Park ES Rebuild
3505 Amherst Ave
Dallas TX 75225

Title
PROPOSED DRAINAGE CALCULATIONS

Project No. 214000361 Scale AS SHOWN
Revision Drawing No.

CG 1.8

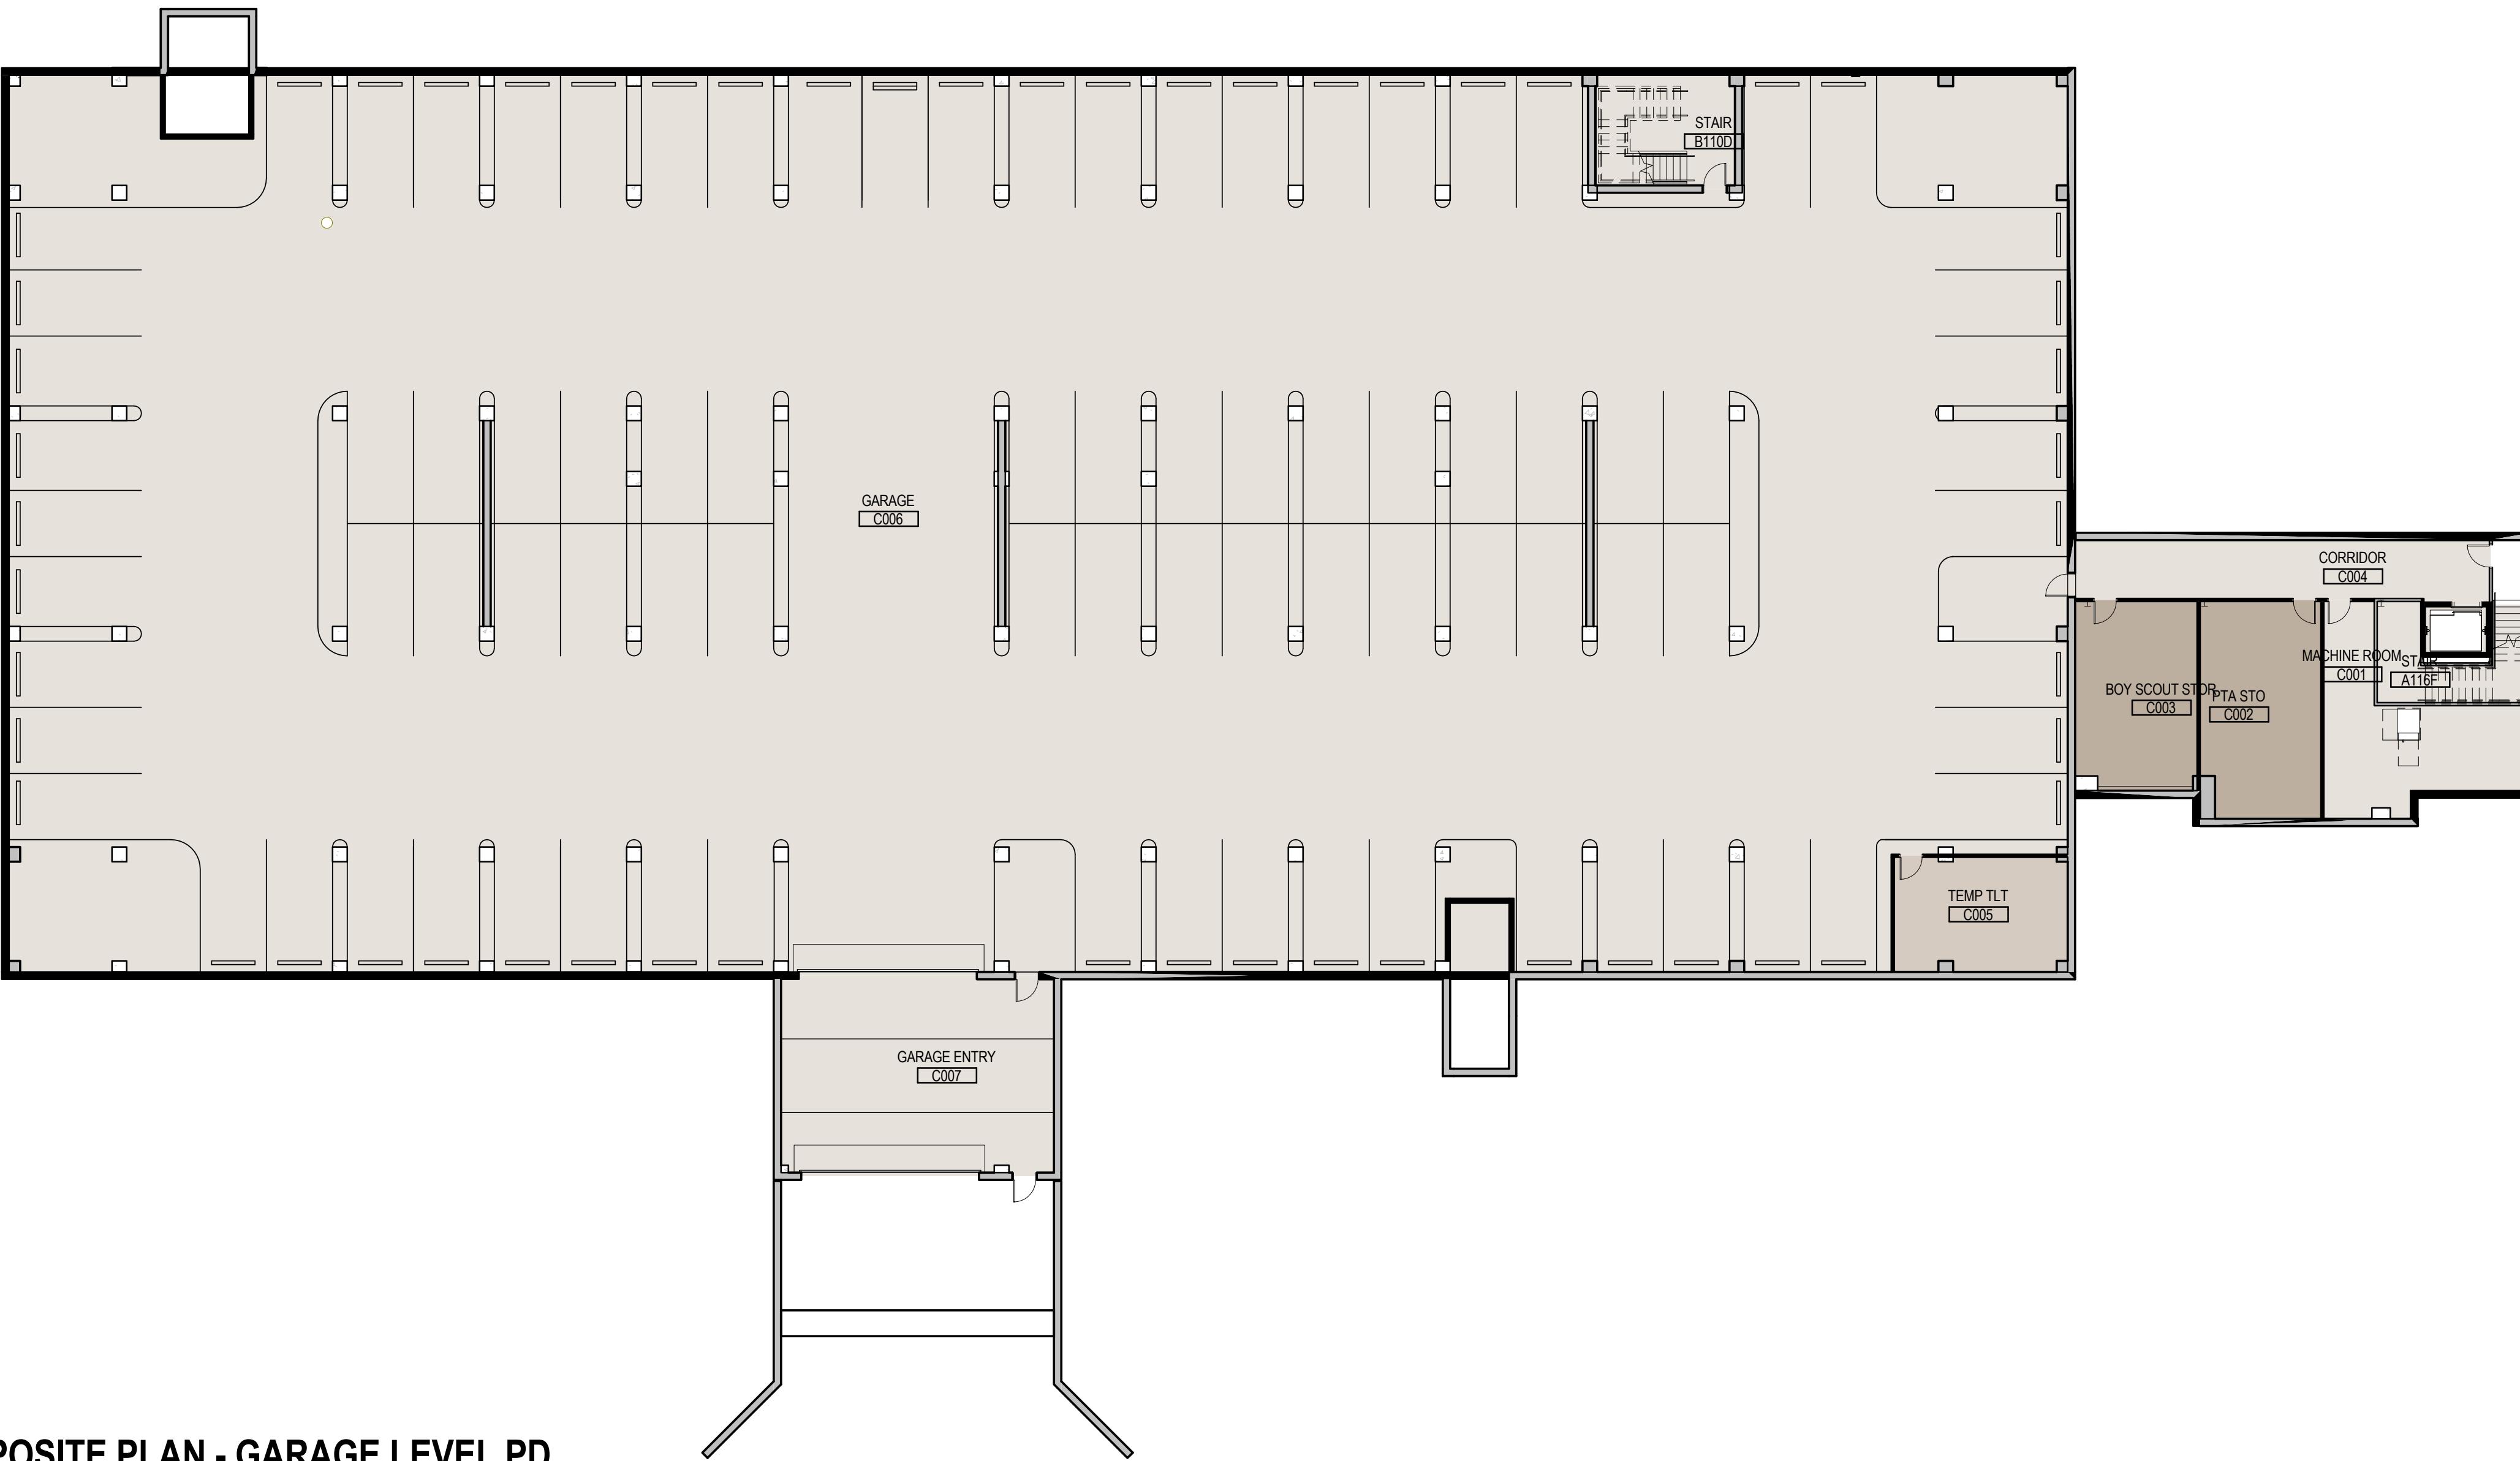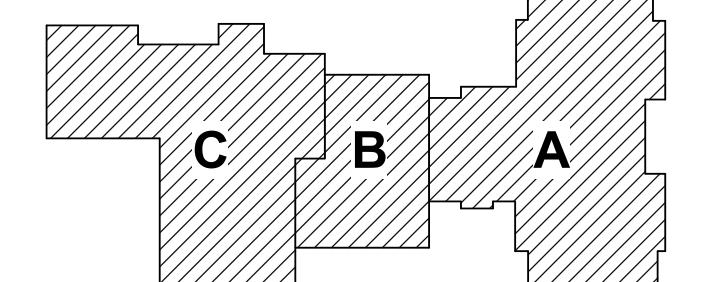

COMPOSITE PLAN - GARAGE LEVEL PD







F2

SECOND LEVEL FLOOR PLA

PD121

1/16" = 1'-0"

PRELIMINARY NOT FOR CONSTRUCTION

Not for permits, pricing or other official purposes.
This document has not been completed or checked and is
for general information or comment only.

Client/Project

University Park ES Rebuild

3505 Amherst Ave
Dallas TX 75225

Title

SECOND LEVEL FLOOR PLAN

PD121

1	Revision 1	By	Appd	Date 1
Revision				YYYY MM DD
PD REVISION SUBMITTAL		Author Approver		2016.11.17
Issued				

PRELIMINARY NOT FOR CONSTRUCTION

Not for permits, pricing or other official purposes.
This document has not been completed or checked and is
for general information or comment only.

Client/Project
Highland Park ISD

University Park ES Rebuild


3505 Amherst Ave
Dallas TX 75225

Title
THIRD LEVEL FLOOR PLAN

Project No.	Scale
214000361	1/16" = 1'-0"
Revision	Drawing No.

F3 THIRD LEVEL FLOOR PLAN
PD131 1/16" = 1'-0"

A
B
C
D
E
F

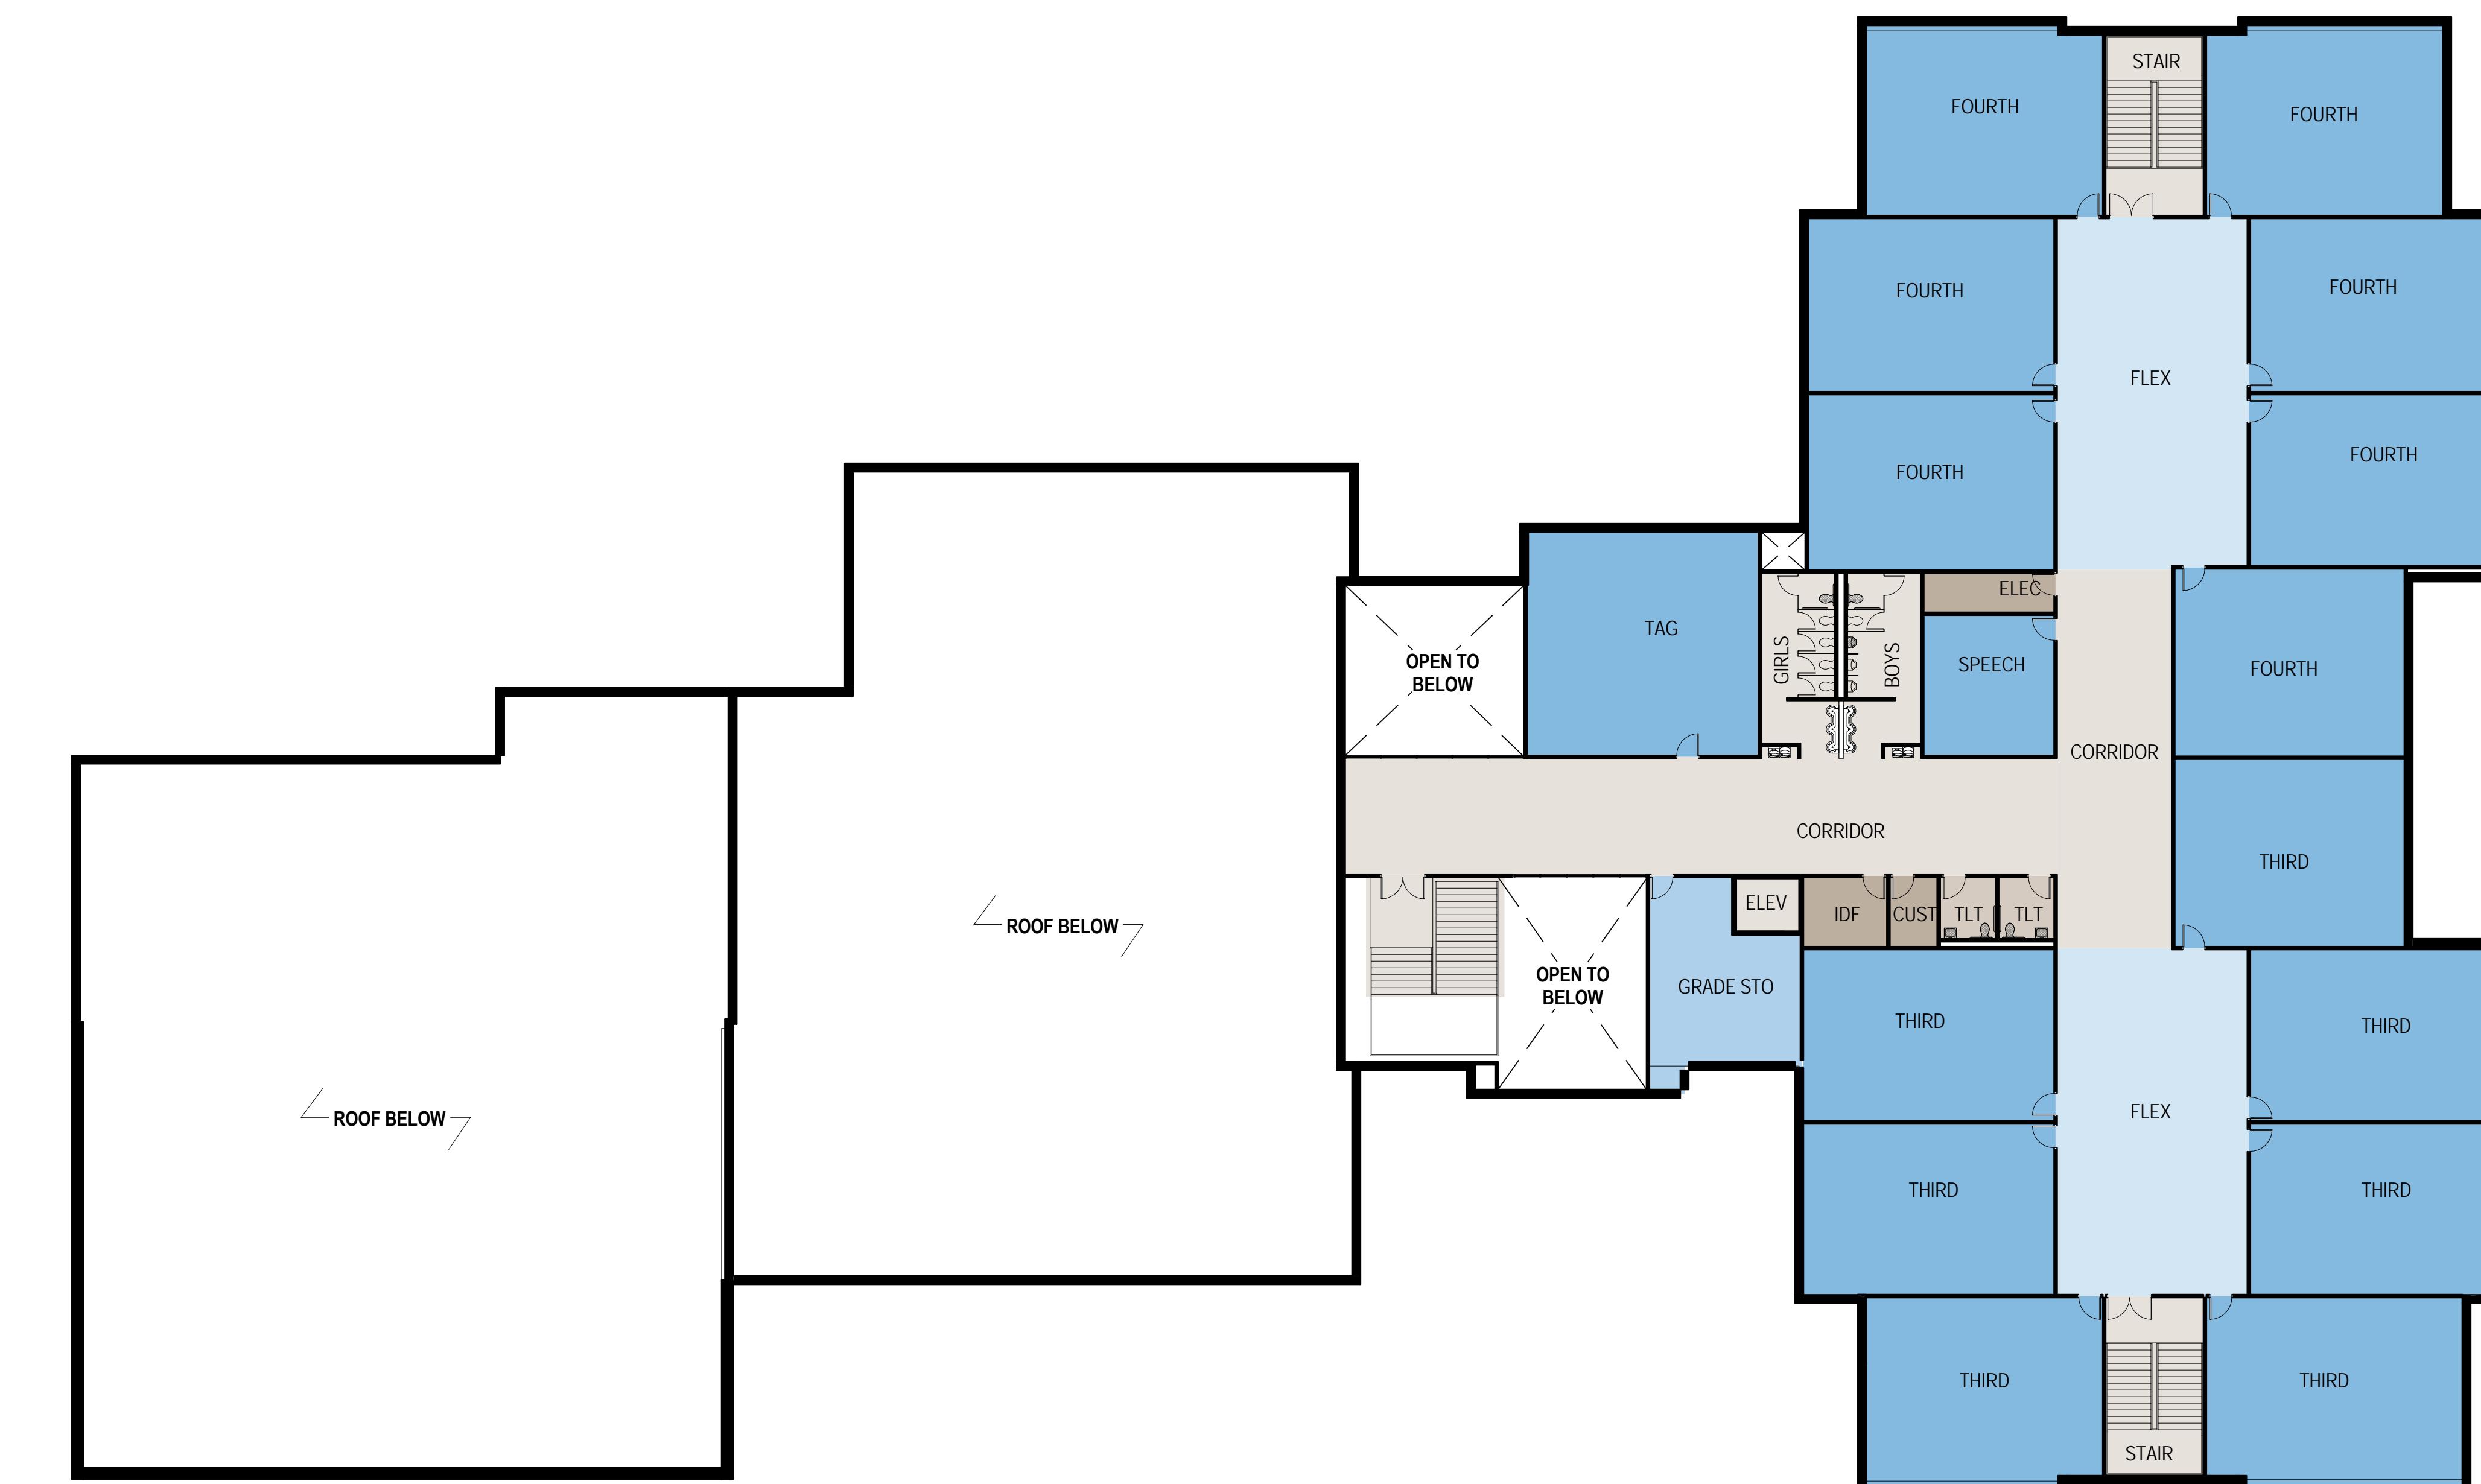



D1 LOVERS ENTRY - RED OPTION
PD200 12' = 1'-0"



D5 LOVERS ENTRY - TAN OPTION
PD200 12' = 1'-0"



F1 AMHERST ENTRY - RED OPTION
PD200 12' = 1'-0"



F5 AMHERST ENTRY - TAN OPTION
PD200 12' = 1'-0"

PRELIMINARY NOT FOR CONSTRUCTION

Not for permits, pricing or other official purposes.
This document has not been completed or checked and is
for general information or comment only.

Client/Project

Highland Park ISD

University Park ES Rebuild


3505 Amherst Ave
Dallas TX 75225

Title


EXTERIOR ELEVATIONS

Project No. 214000361 Scale 1/16" = 1'-0"
Revision Drawing No.


PD201

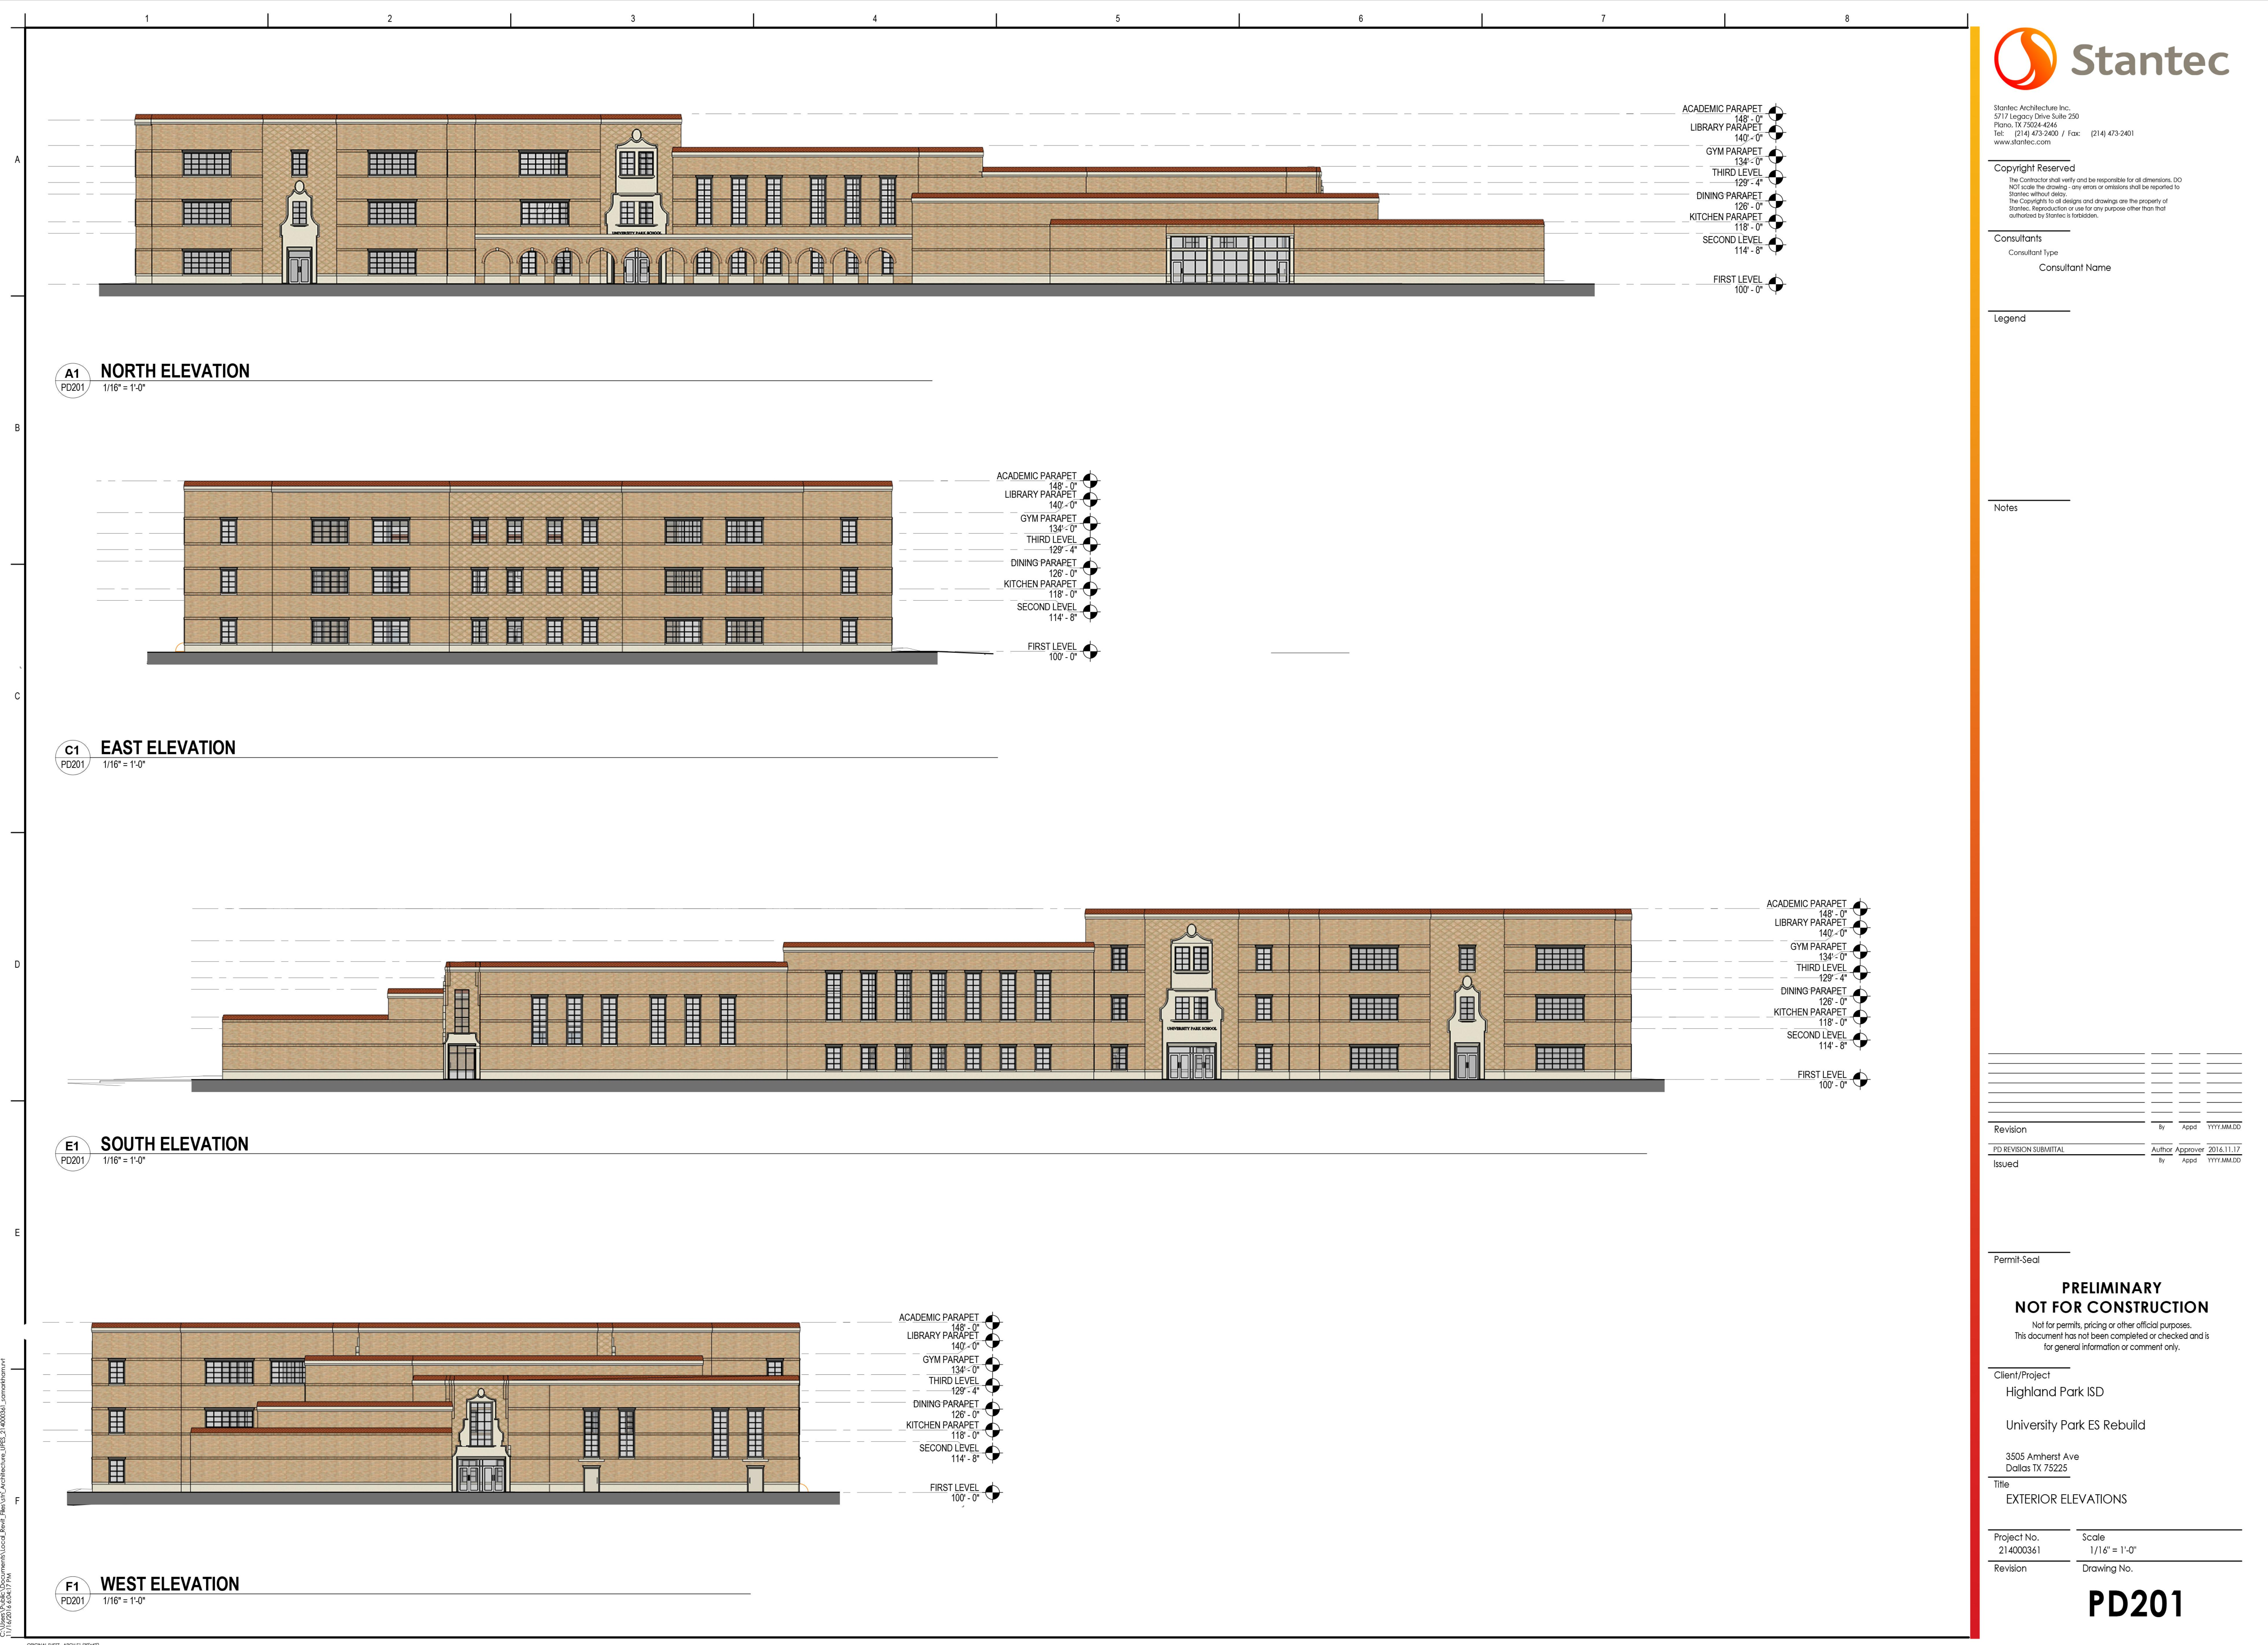


NOTE:
MASSING PERSPECTIVES FOR RTUS SHOWN WITHOUT SCREEN WALLS
TOP OF WORST CASE SCREEN WALL TO BE 54' IF REQUIRED

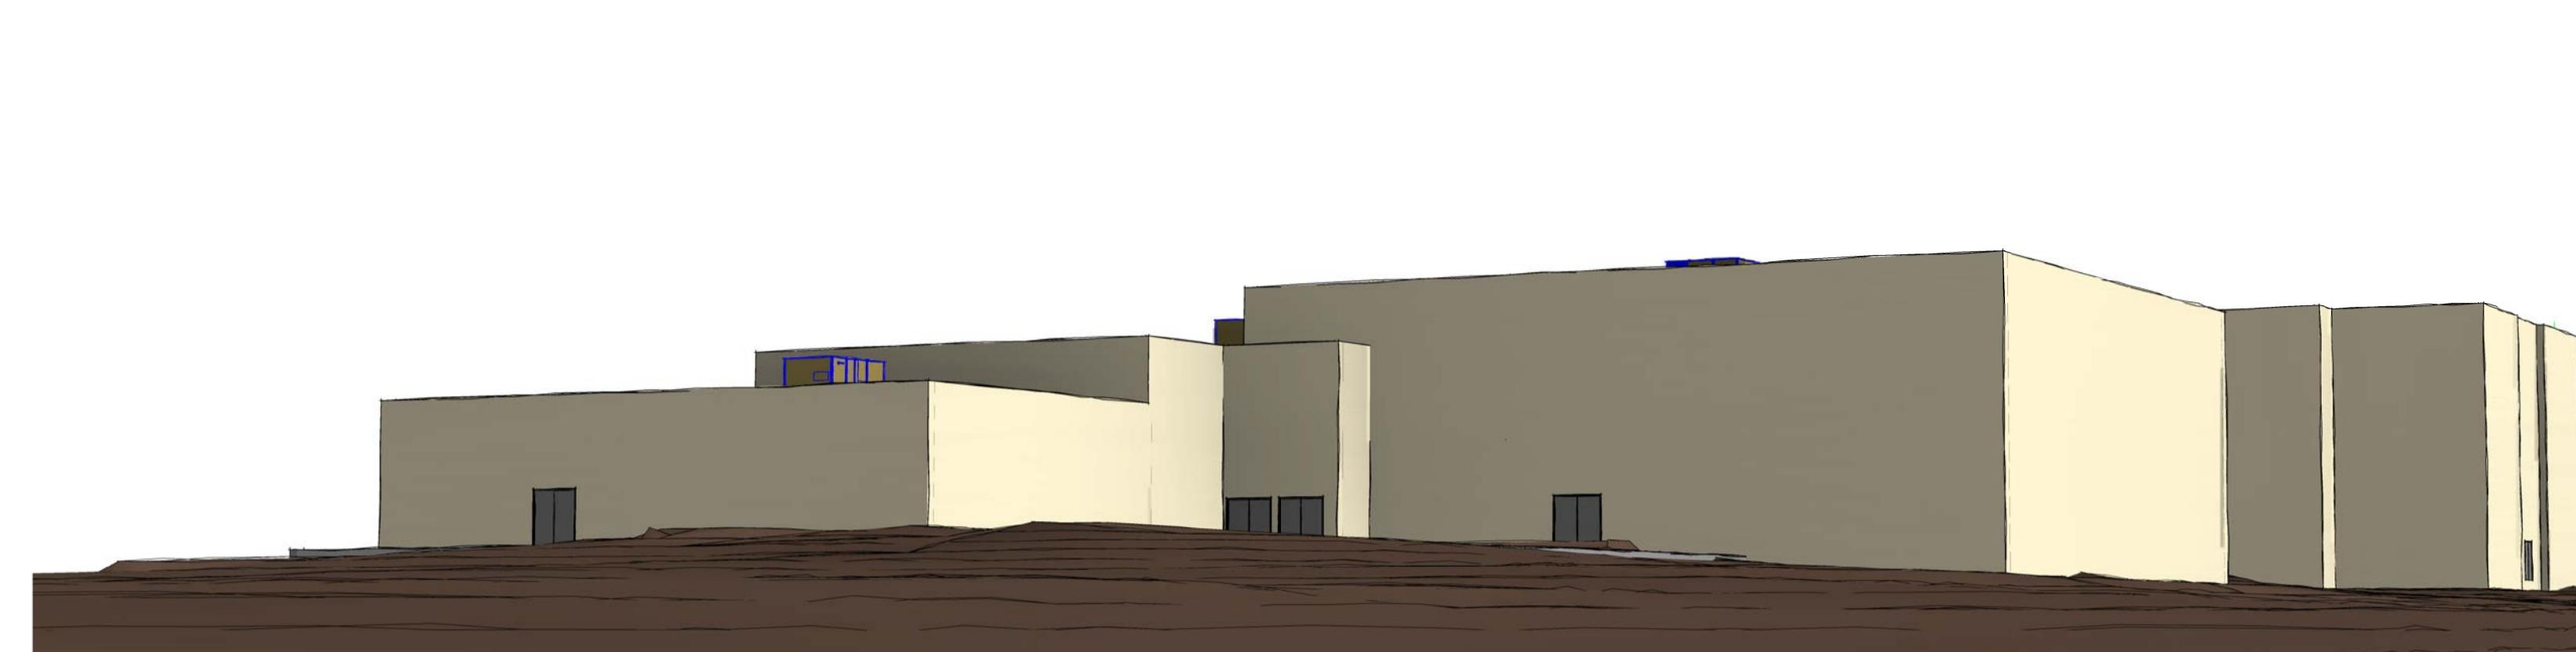


B1 Thackery/Lovers towards Gym/Kitchen
PD210

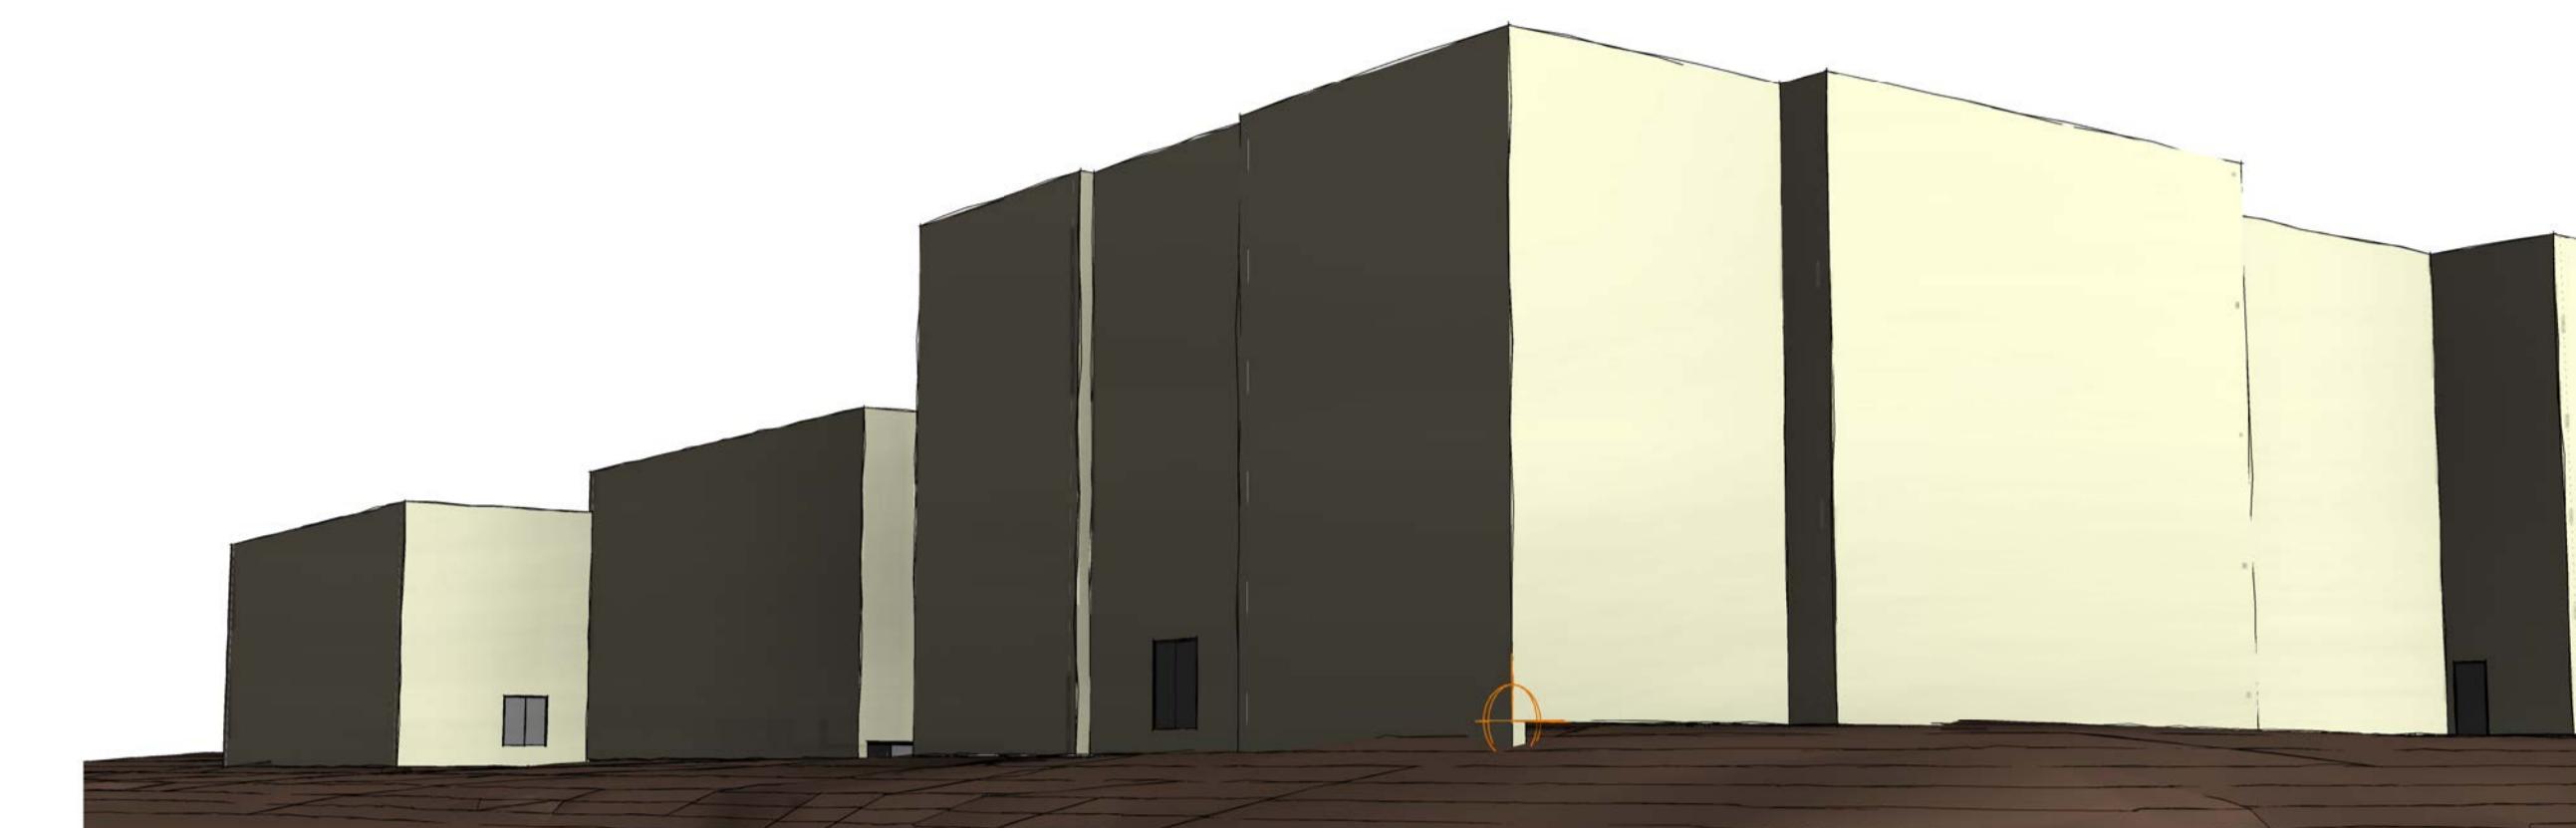


B5 Lovers/Dickens Toward Building
PD210

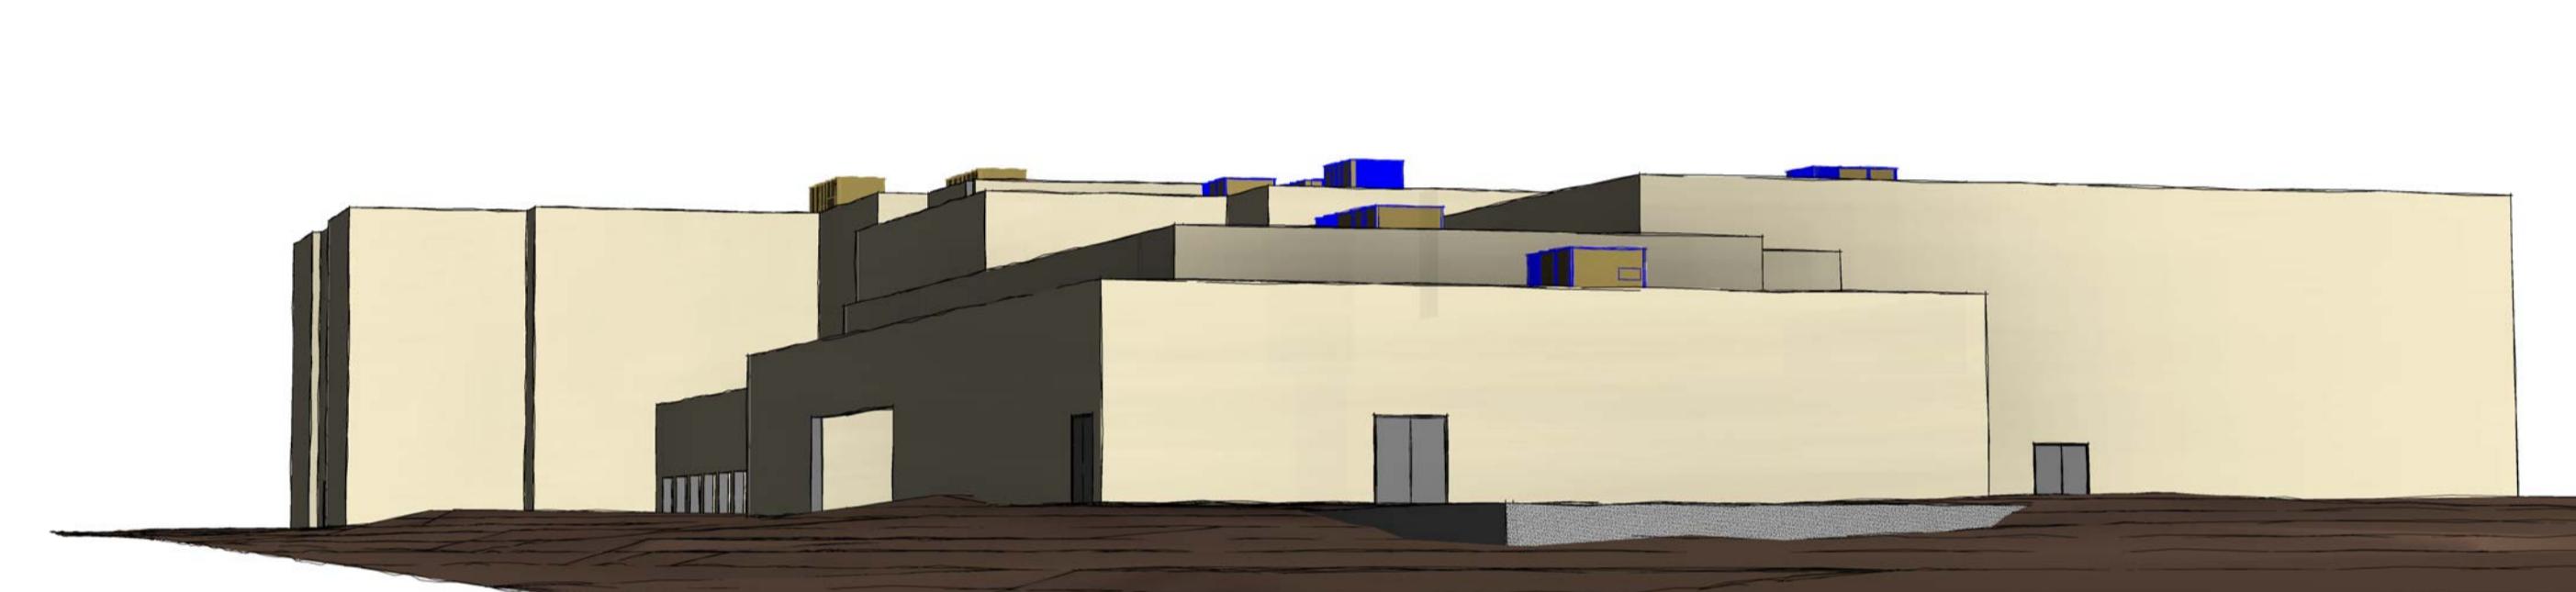


C1 Thackery/Amherst towards School
PD210

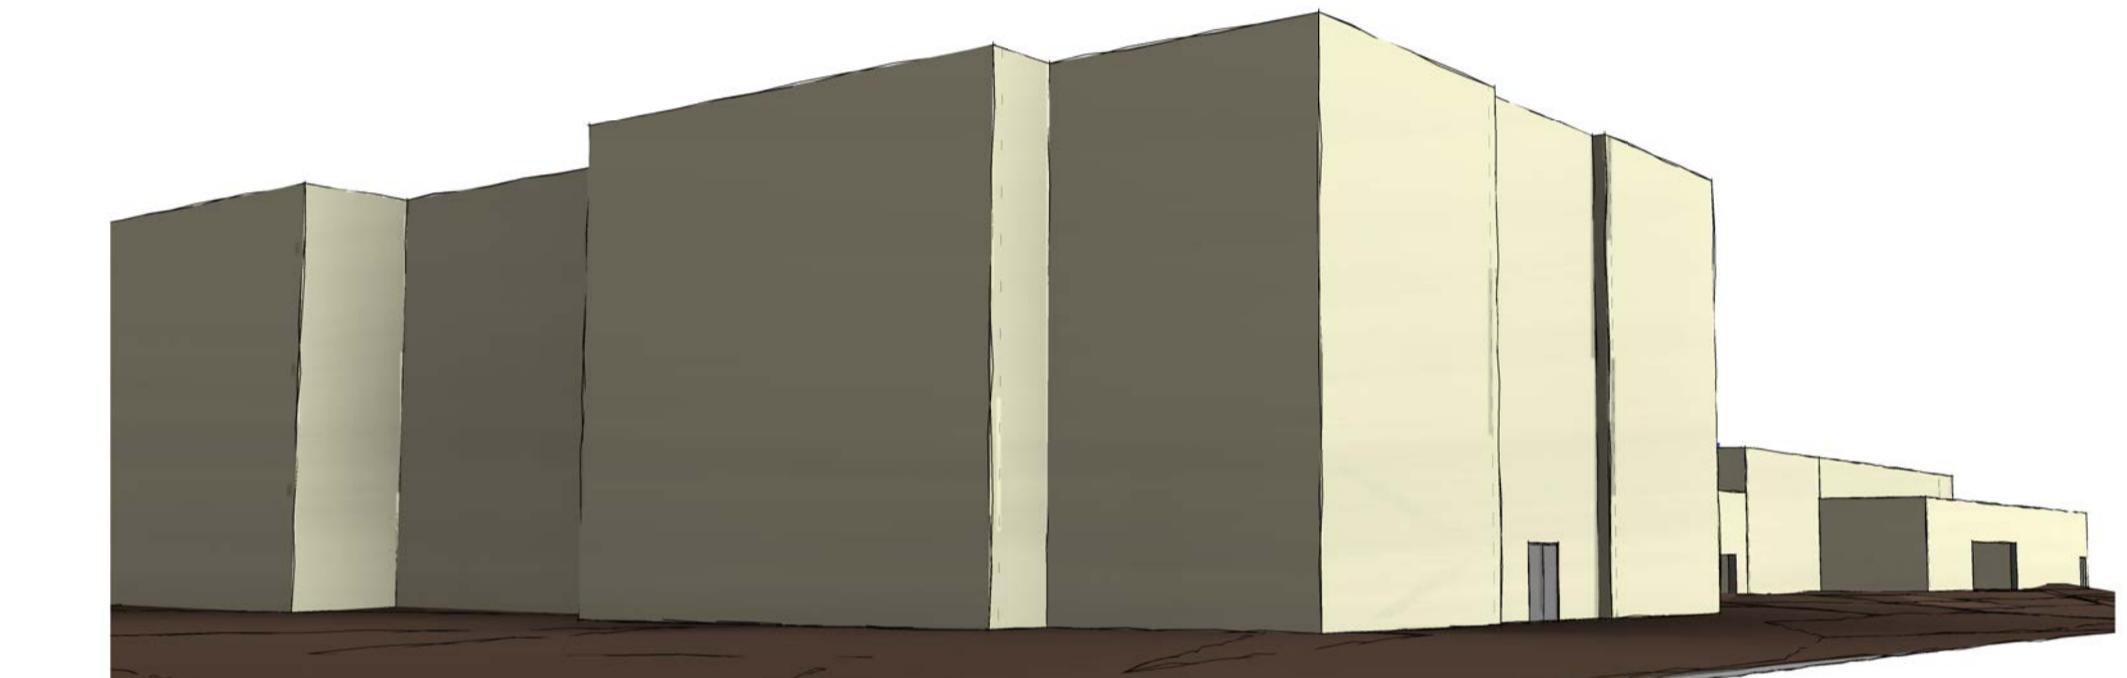


C5 Amherst/Dickens toward Building
PD210

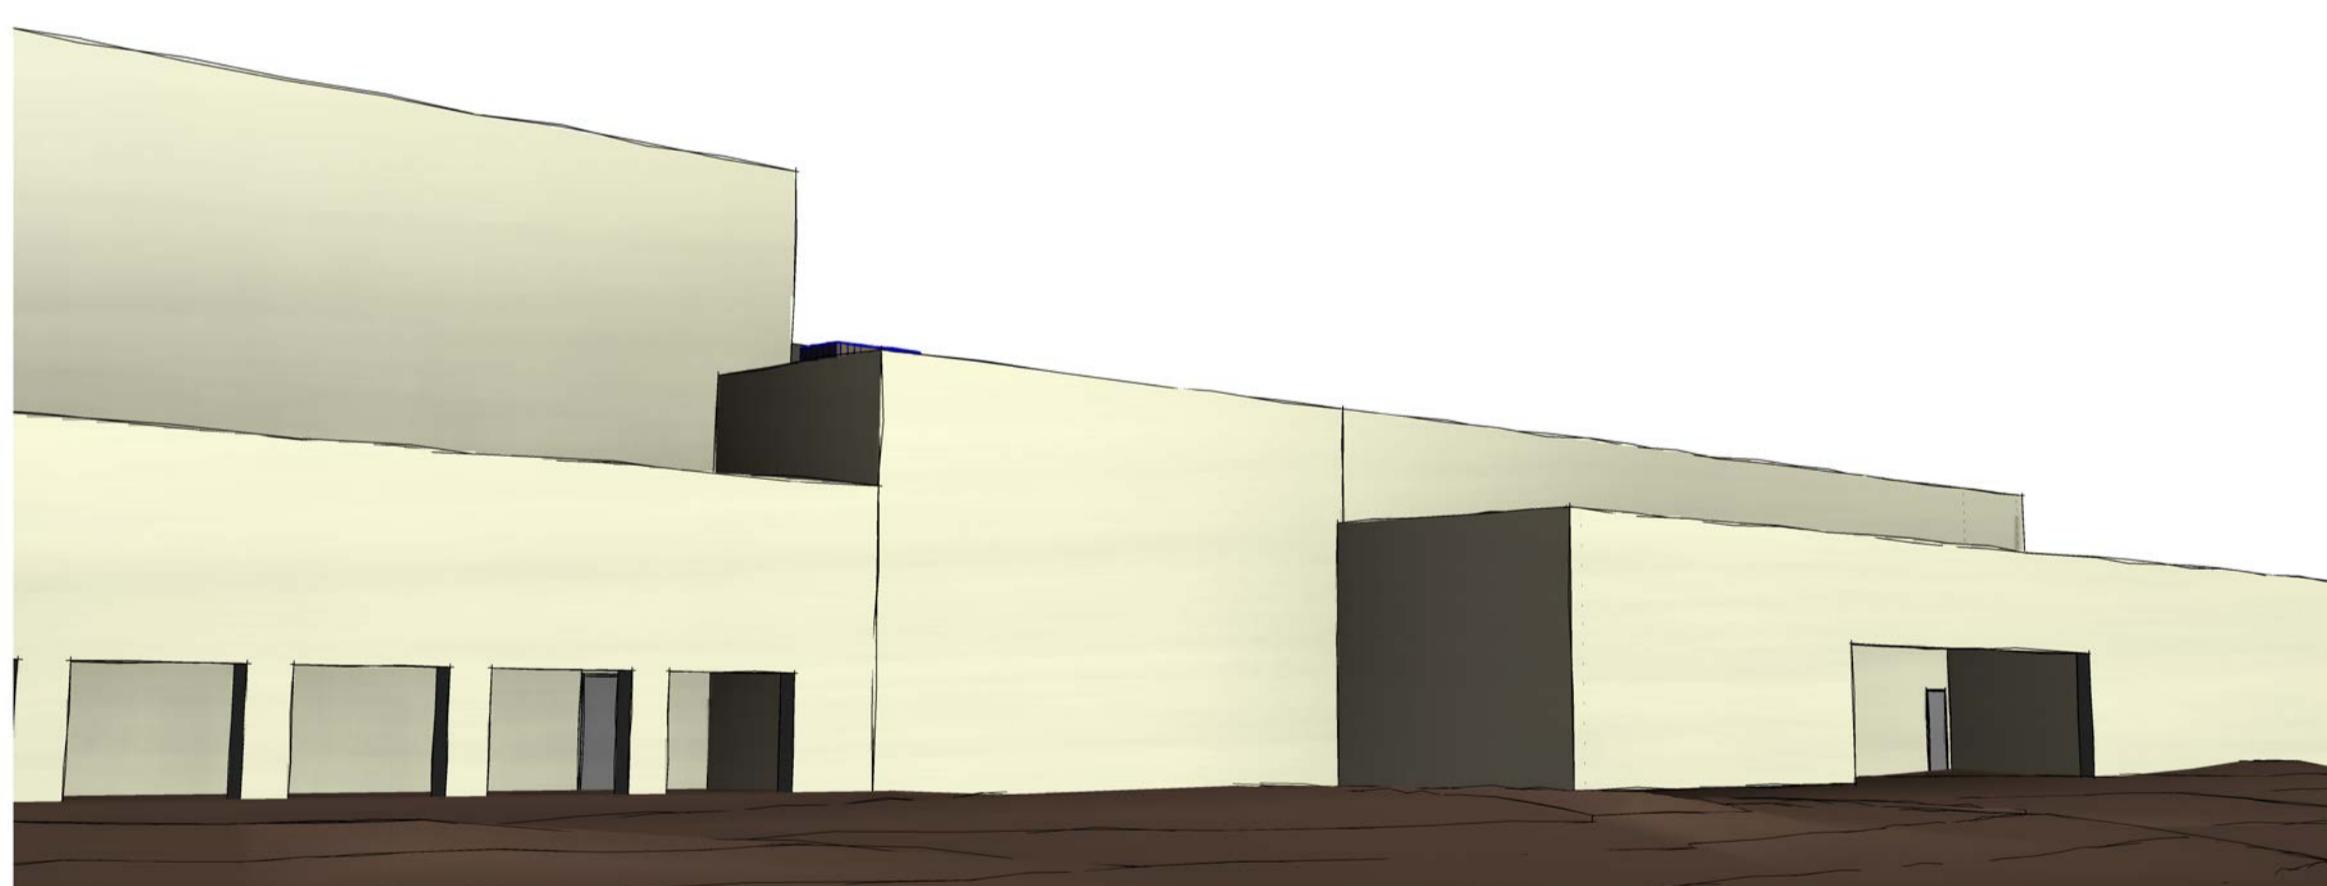


E1 Across Amherst toward Dining/Kitchen
PD210

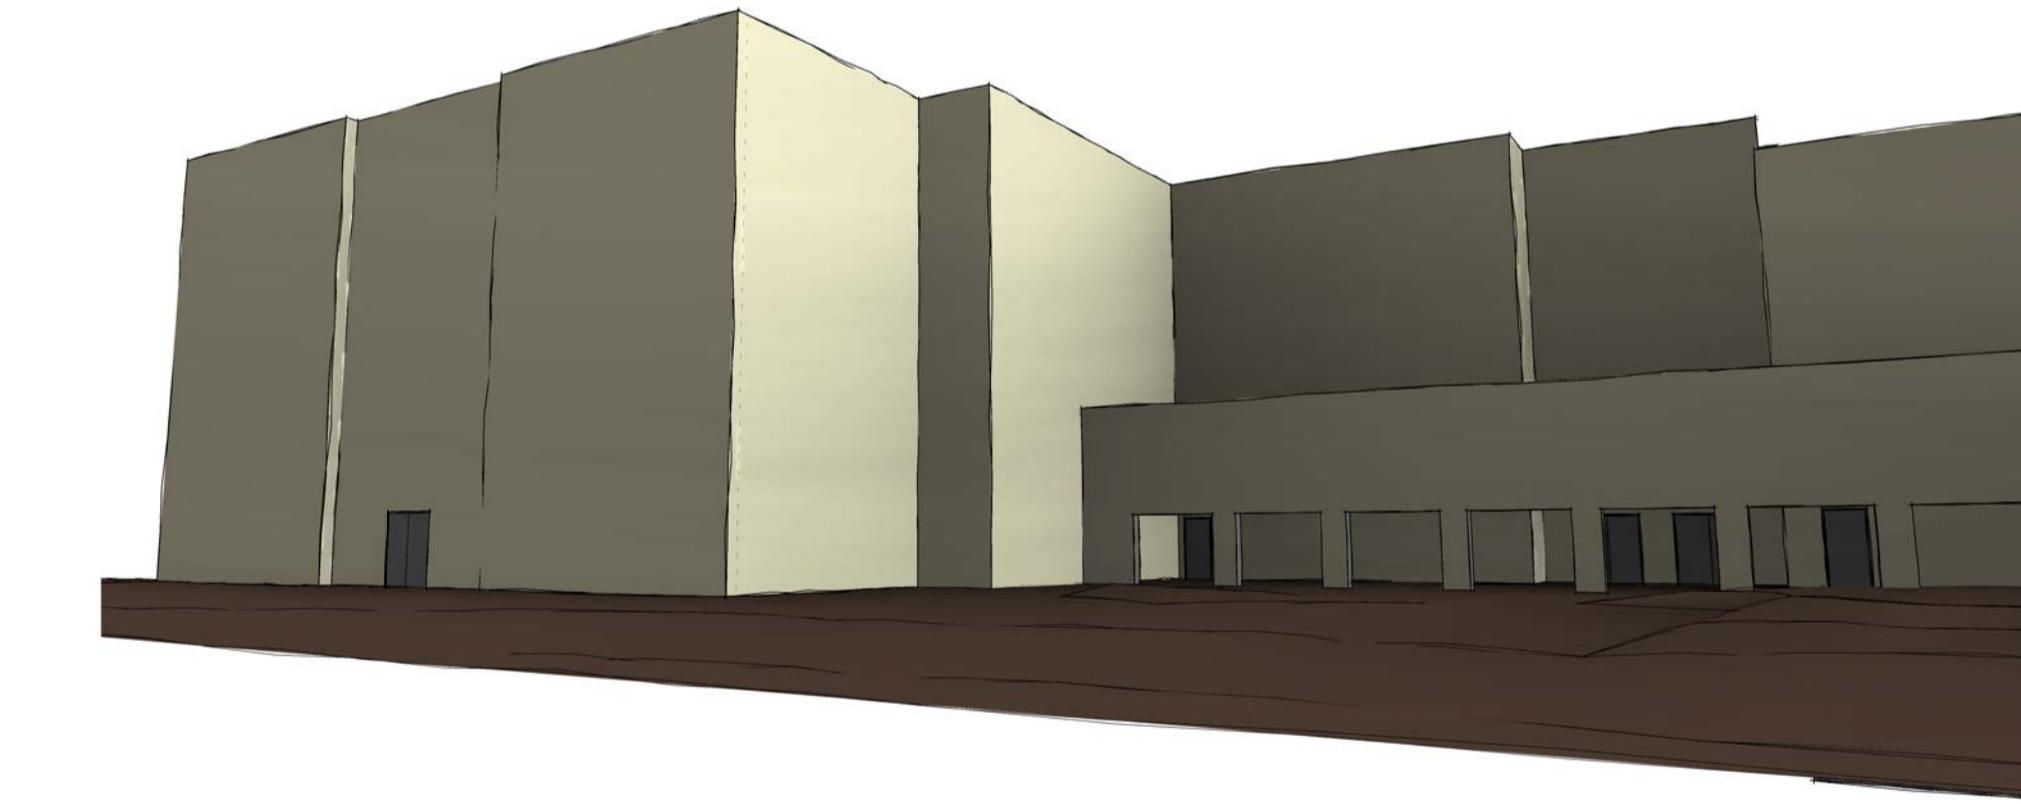


E5 Across Amherst toward Classrooms
PD210

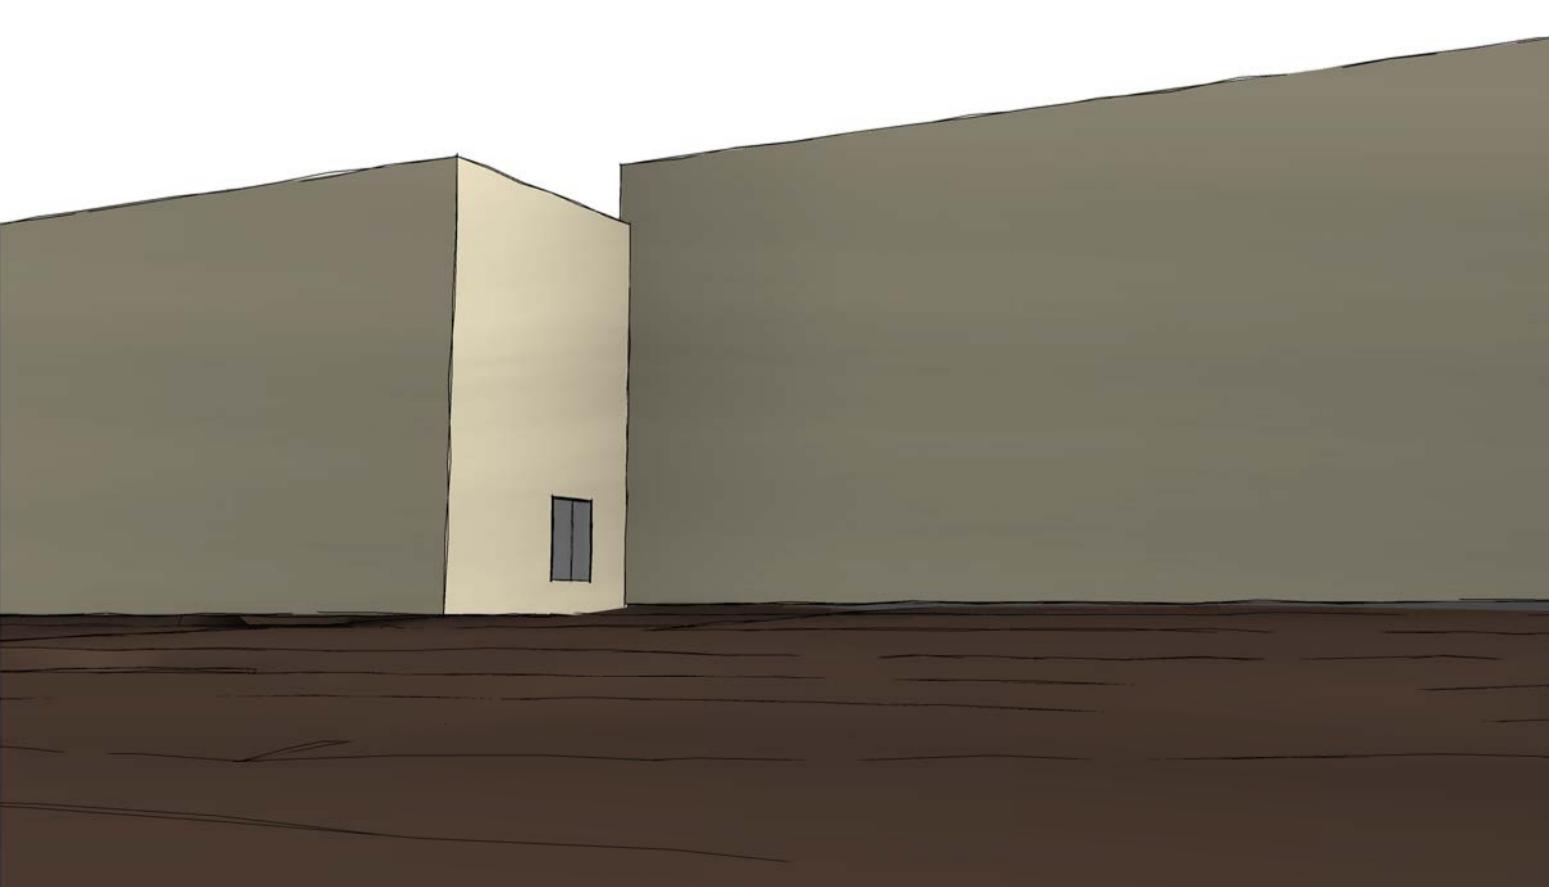

F1 Lovers Crosswalk towards Gym
PD210

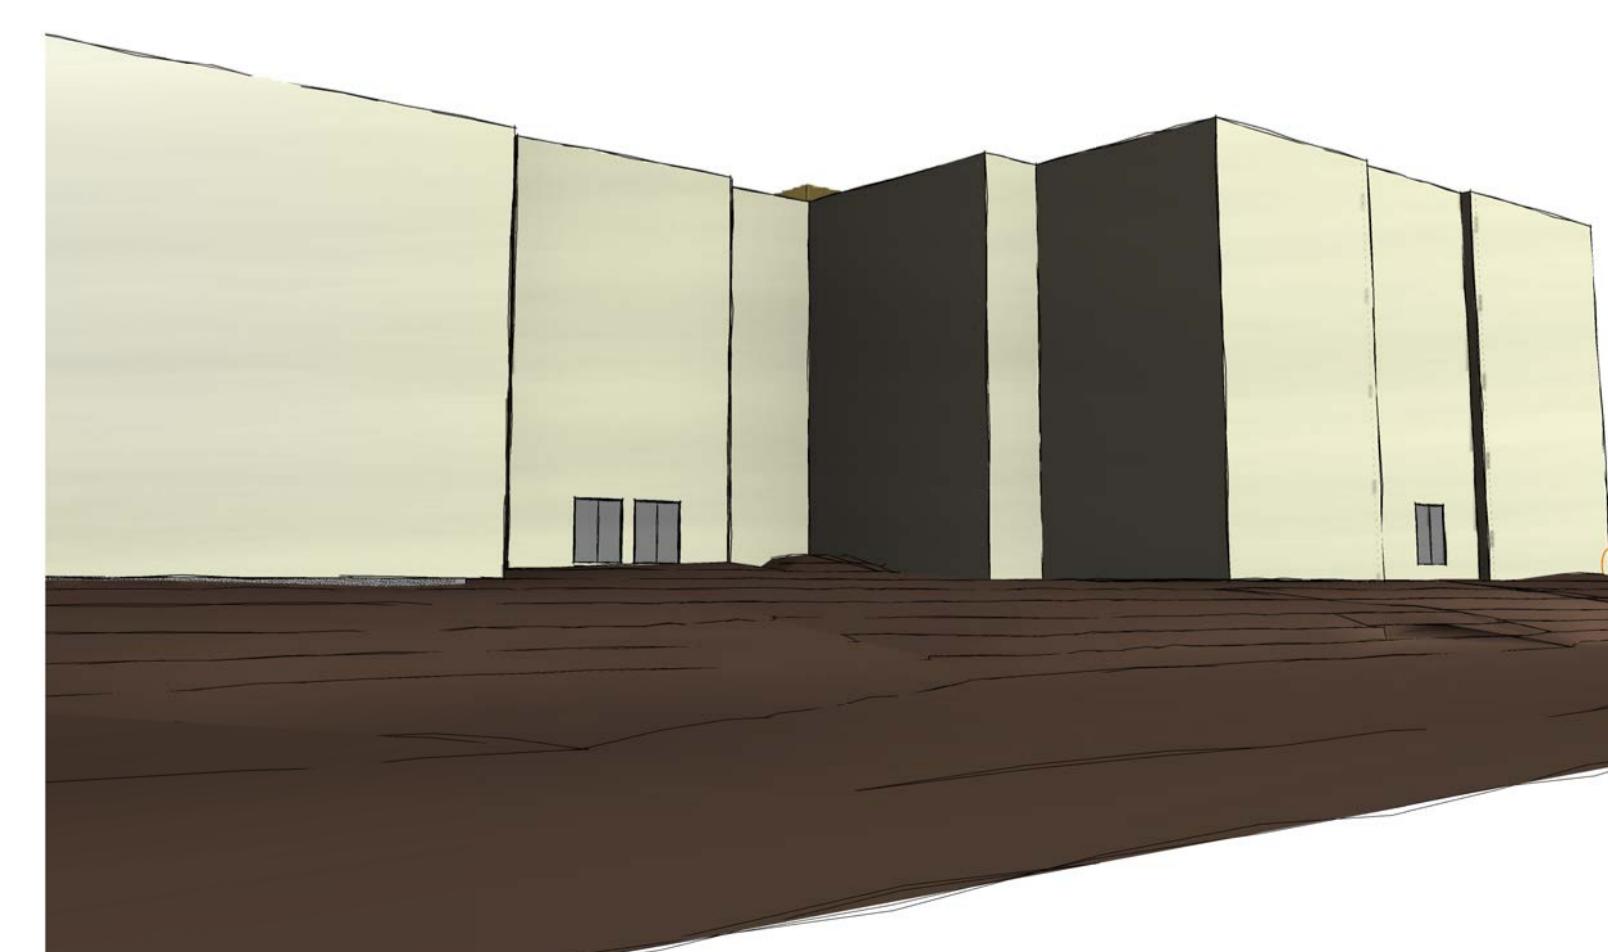

F4 Lovers Crosswalk towards Classroom
PD210

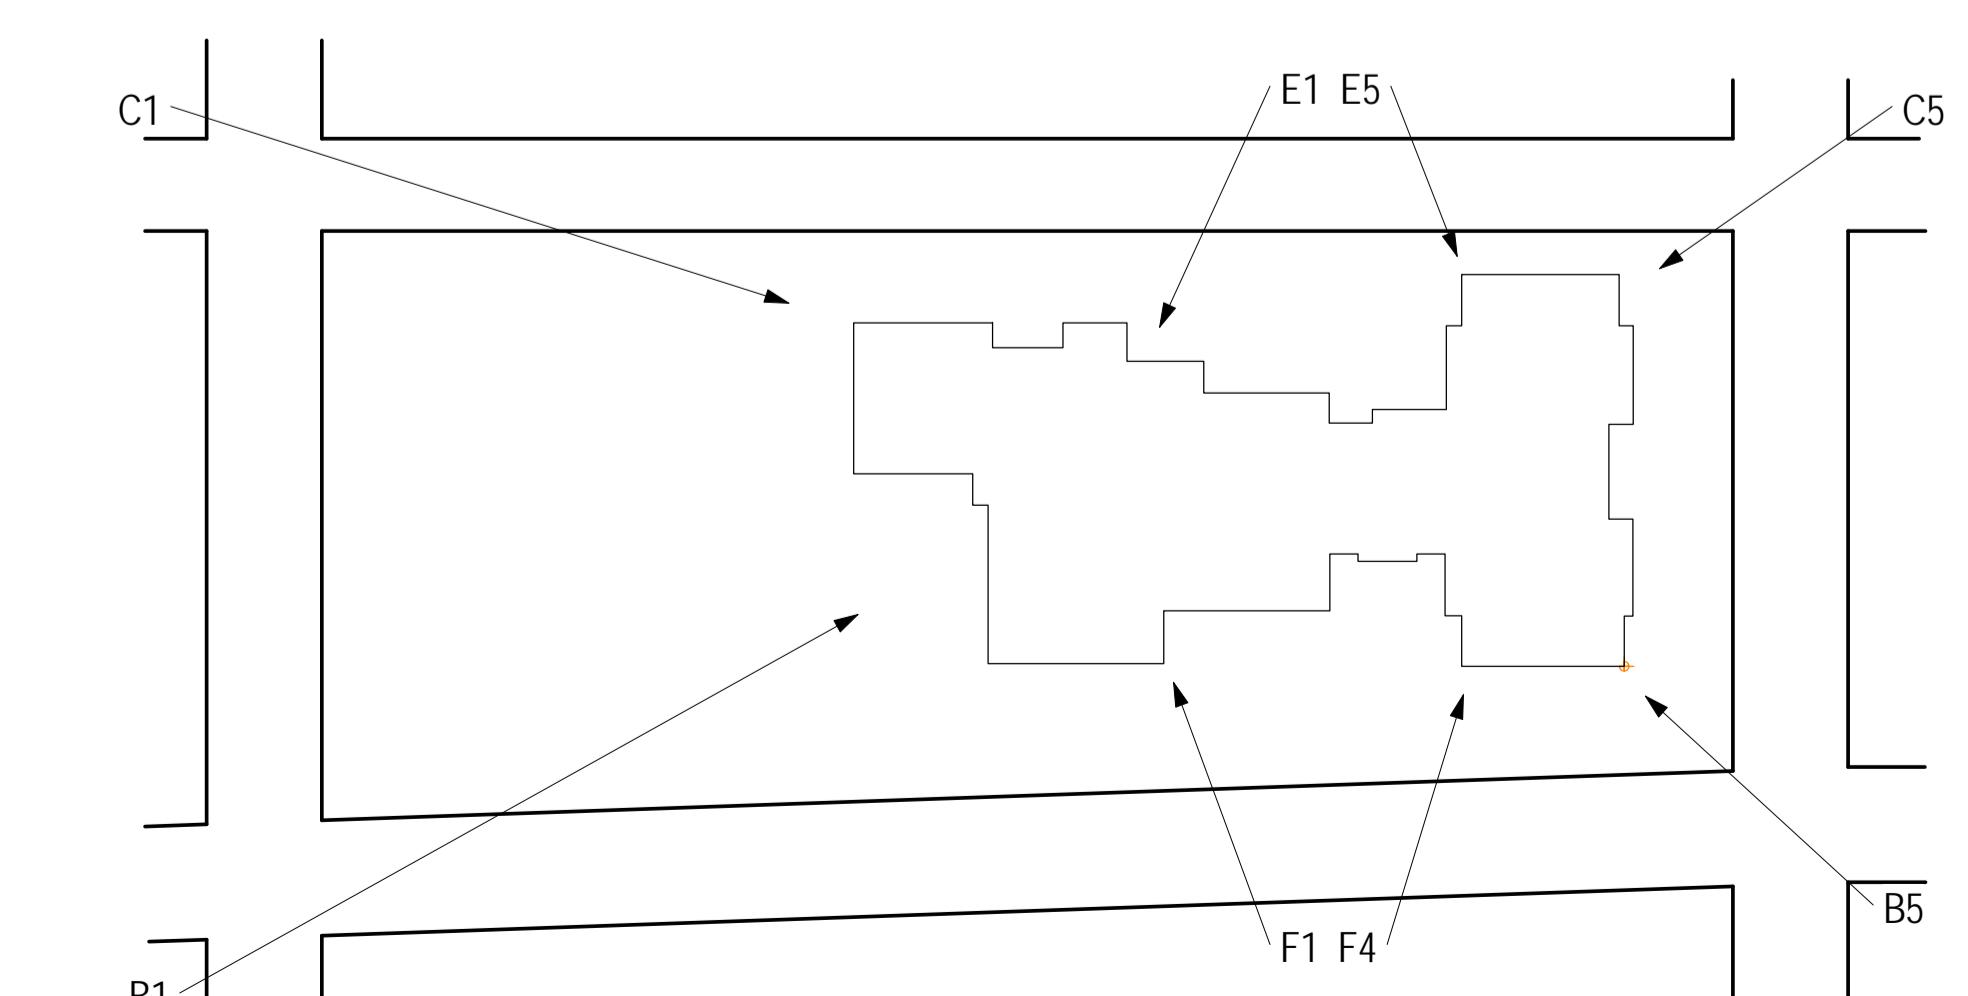

F6 PERSPECTIVE KEY
PD210 1" = 100'-0"

ORDINANCE NO. _____

AN ORDINANCE OF THE CITY OF UNIVERSITY PARK, TEXAS, AMENDING THE COMPREHENSIVE ZONING ORDINANCE OF THE CITY OF UNIVERSITY PARK, BY APPROVING AN AMENDED DETAILED SITE PLAN FOR PLANNED DEVELOPMENT DISTRICT 15 "PD-15" FOR UNIVERSITY PARK ELEMENTARY SCHOOL, THE PROPERTY BEING DESCRIBED AS LOTS 1-26, BLOCK C, OF THE UNIVERSITY HEIGHTS ADDITION REVISED, AN ADDITION TO THE CITY OF UNIVERSITY PARK, DALLAS COUNTY, TEXAS, RECORDED IN VOLUME 3, PAGE 383, OF THE MAP RECORDS OF DALLAS COUNTY, TEXAS AND MORE COMMONLY KNOWN AS 3505 AMHERST; PROVIDING SPECIAL CONDITIONS; PROVIDING FOR THE REPEAL OF ALL ORDINANCES IN CONFLICT; PROVIDING A SEVERABILITY CLAUSE; PROVIDING FOR A PENALTY OF FINE NOT TO EXCEED THE SUM OF TWO THOUSAND DOLLARS (\$2,000.00) FOR EACH OFFENSE; AND PROVIDING AN EFFECTIVE DATE.

DULY PASSED by the City Council of the City of University Park, Texas, on the _____ day of _____ 2017.

APPROVED:

MAYOR

ATTEST:

CITY SECRETARY